## A HUNTER RENAISSANCE DEVELOPMENT

REDMOND, OREGON

NW ELM AVE.


# CONSTRUCTION

### DPO IFCT INFORMATION


Legal Address:	NW 27th and NW Elm Redmond, Oregon	Buiding Area:	Unit A	<u>Unit B</u>
	Treumond, Oregon	1st Floor	736 sf	736 sf
Applicable Code:	IRC 2014 Oregon Residential Specialty Code	2nd Floor	736 sf	440 sf
Construction Type:	V–B			
Stories:	2	Total:	1,472 sf	1,176 sf
Fire Sprinkled:	No			
Required Footing Depth:	18 inches			
Design Wind Speed:	110 mph, risk category II			
Required Seismic Design Category:	D2 Residential			
Ground Snow Load:	15 psf add to flat roofs			
Fire Separations Required:	"Modified" 2—hour wall party wall at common walls between units			




### VICINITY PLAN

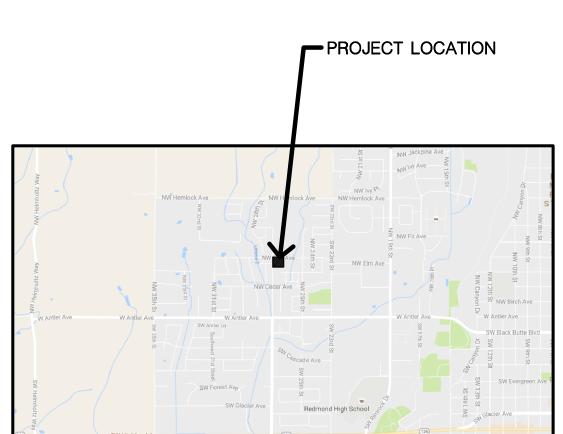

### SYMBOL KEY

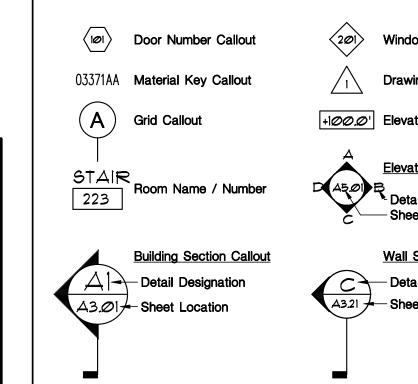

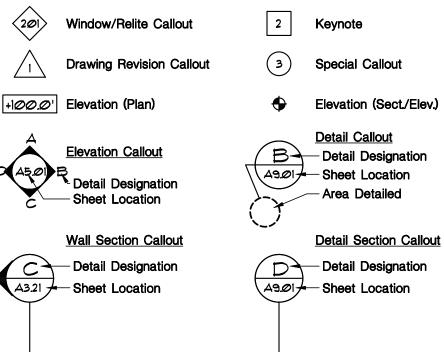

### PROJECT TEAM

### OWNER: Hunter Renaissance Development 2001 W. CHURCHILL STREET CHICAGO, ILLINOIS 60647

ARCHITECT: think Architecture, pllc 1529 COLUMBIA PARK TRAIL, SUITE B312 RICHLAND, WASHINGTON 99352

### CONTRACTOR Shawn Vickers Construction

20614 REDWING LANE BEND, OREGON 97702 TEL: (541) 948-6372

TEL: (773) 278-8448

TEL: (208) 850-7180

### STRUCTURAL

Axiom, pllc 121 N. 9th. SUITE 401 BOISE, IDAHO 83702 TEL: (208) 639-4520

### **MECHANICAL:** Tikker Engineering 9384 W. OVERLAND., SUITE 190 BOISE, IDAHO 83709

TEL: (208) 658-0218 **ELECTRICAL:** 

### e2co

800 S. INDUSTRY WAY, SUITE 350 MERIDIAN, IDAHO 83642 TEL: (208) 378-4451

### SHEET INDEX

ARCH	<u>IITECTURAL</u>
<b>00.0</b> /	Cover Sheet
<b>\1.01</b>	Site Plan
<b>\1.02</b>	Site Details
<b>\1.03</b>	Covered Parking Details
<b>\2.01</b>	Floor Plans
\2.02	Unit Plans - Unit A
\2.03	Unit Plans - Unit B
<b>\2.11</b>	Roof Plan
<b>\3.01</b>	Exterior Elevations
<b>\3.11</b>	Building Sections
\3.21	Wall Sections
<b>∖</b> 5.01	Interior Elevations

Casework Details Schedules **Door and Window Types** A7.01 Details

C2.01 Civil Site Plan

### STRUCTURAL

S0.02 General Notes S0.03 General Notes Foundation Plan

### S0.01 Structural Cover Sheet

S1.02 Floor Framing Plan

STRUCTURAL (Cont.)						
S1.03	Roof Framing Plan					
S5.01	Concrete Standard Details					
S5.02	Concrete Standard Details					
S5.03	Foundation Details					
S5.61	Wood Standard Details					
S5.62	Wood Standard Details					
S5.63	Floor Framing Details					
S5.64	Floor Framing Details					
S6.01	Concrete Schedules					
S6.61	Wood Schedules					

### **MECHANICAL**

M1.00 Mechanical Cover Sheet M2.00 HVAC Plan M3.00 Waste Plan M4.00 Plumbing Plan

### **ELECTRICAL**

Electrical Symbols list & Sheet Index Electrical Site Plan E2.0L First Floor Lighting Plan E2.0P First Floor Power Plan

E2.0S First Floor Special Systems Plan E2.1L Second Floor Lighting Plan Second Floor Power Plan

E2.1S Second Floor Special Systems Plan One Line Diagram and Electrical Details **A0.00** 

THESE DESIGNS AND DRAWINGS ARE THE EXCLUSIVE PROPERTY OF THINK ARCHITECTURE, PLLC, AND ARE NOT TO BE USED OR DUPLICATED WITHOUT PERMISSION. COPYRIGHT © 2016, ALL RIGHTS RESERVED.






COVER SHEET

AS NOTED

Project Number


NOVEMBER 8, 2016

1602SHEETSET.DWG

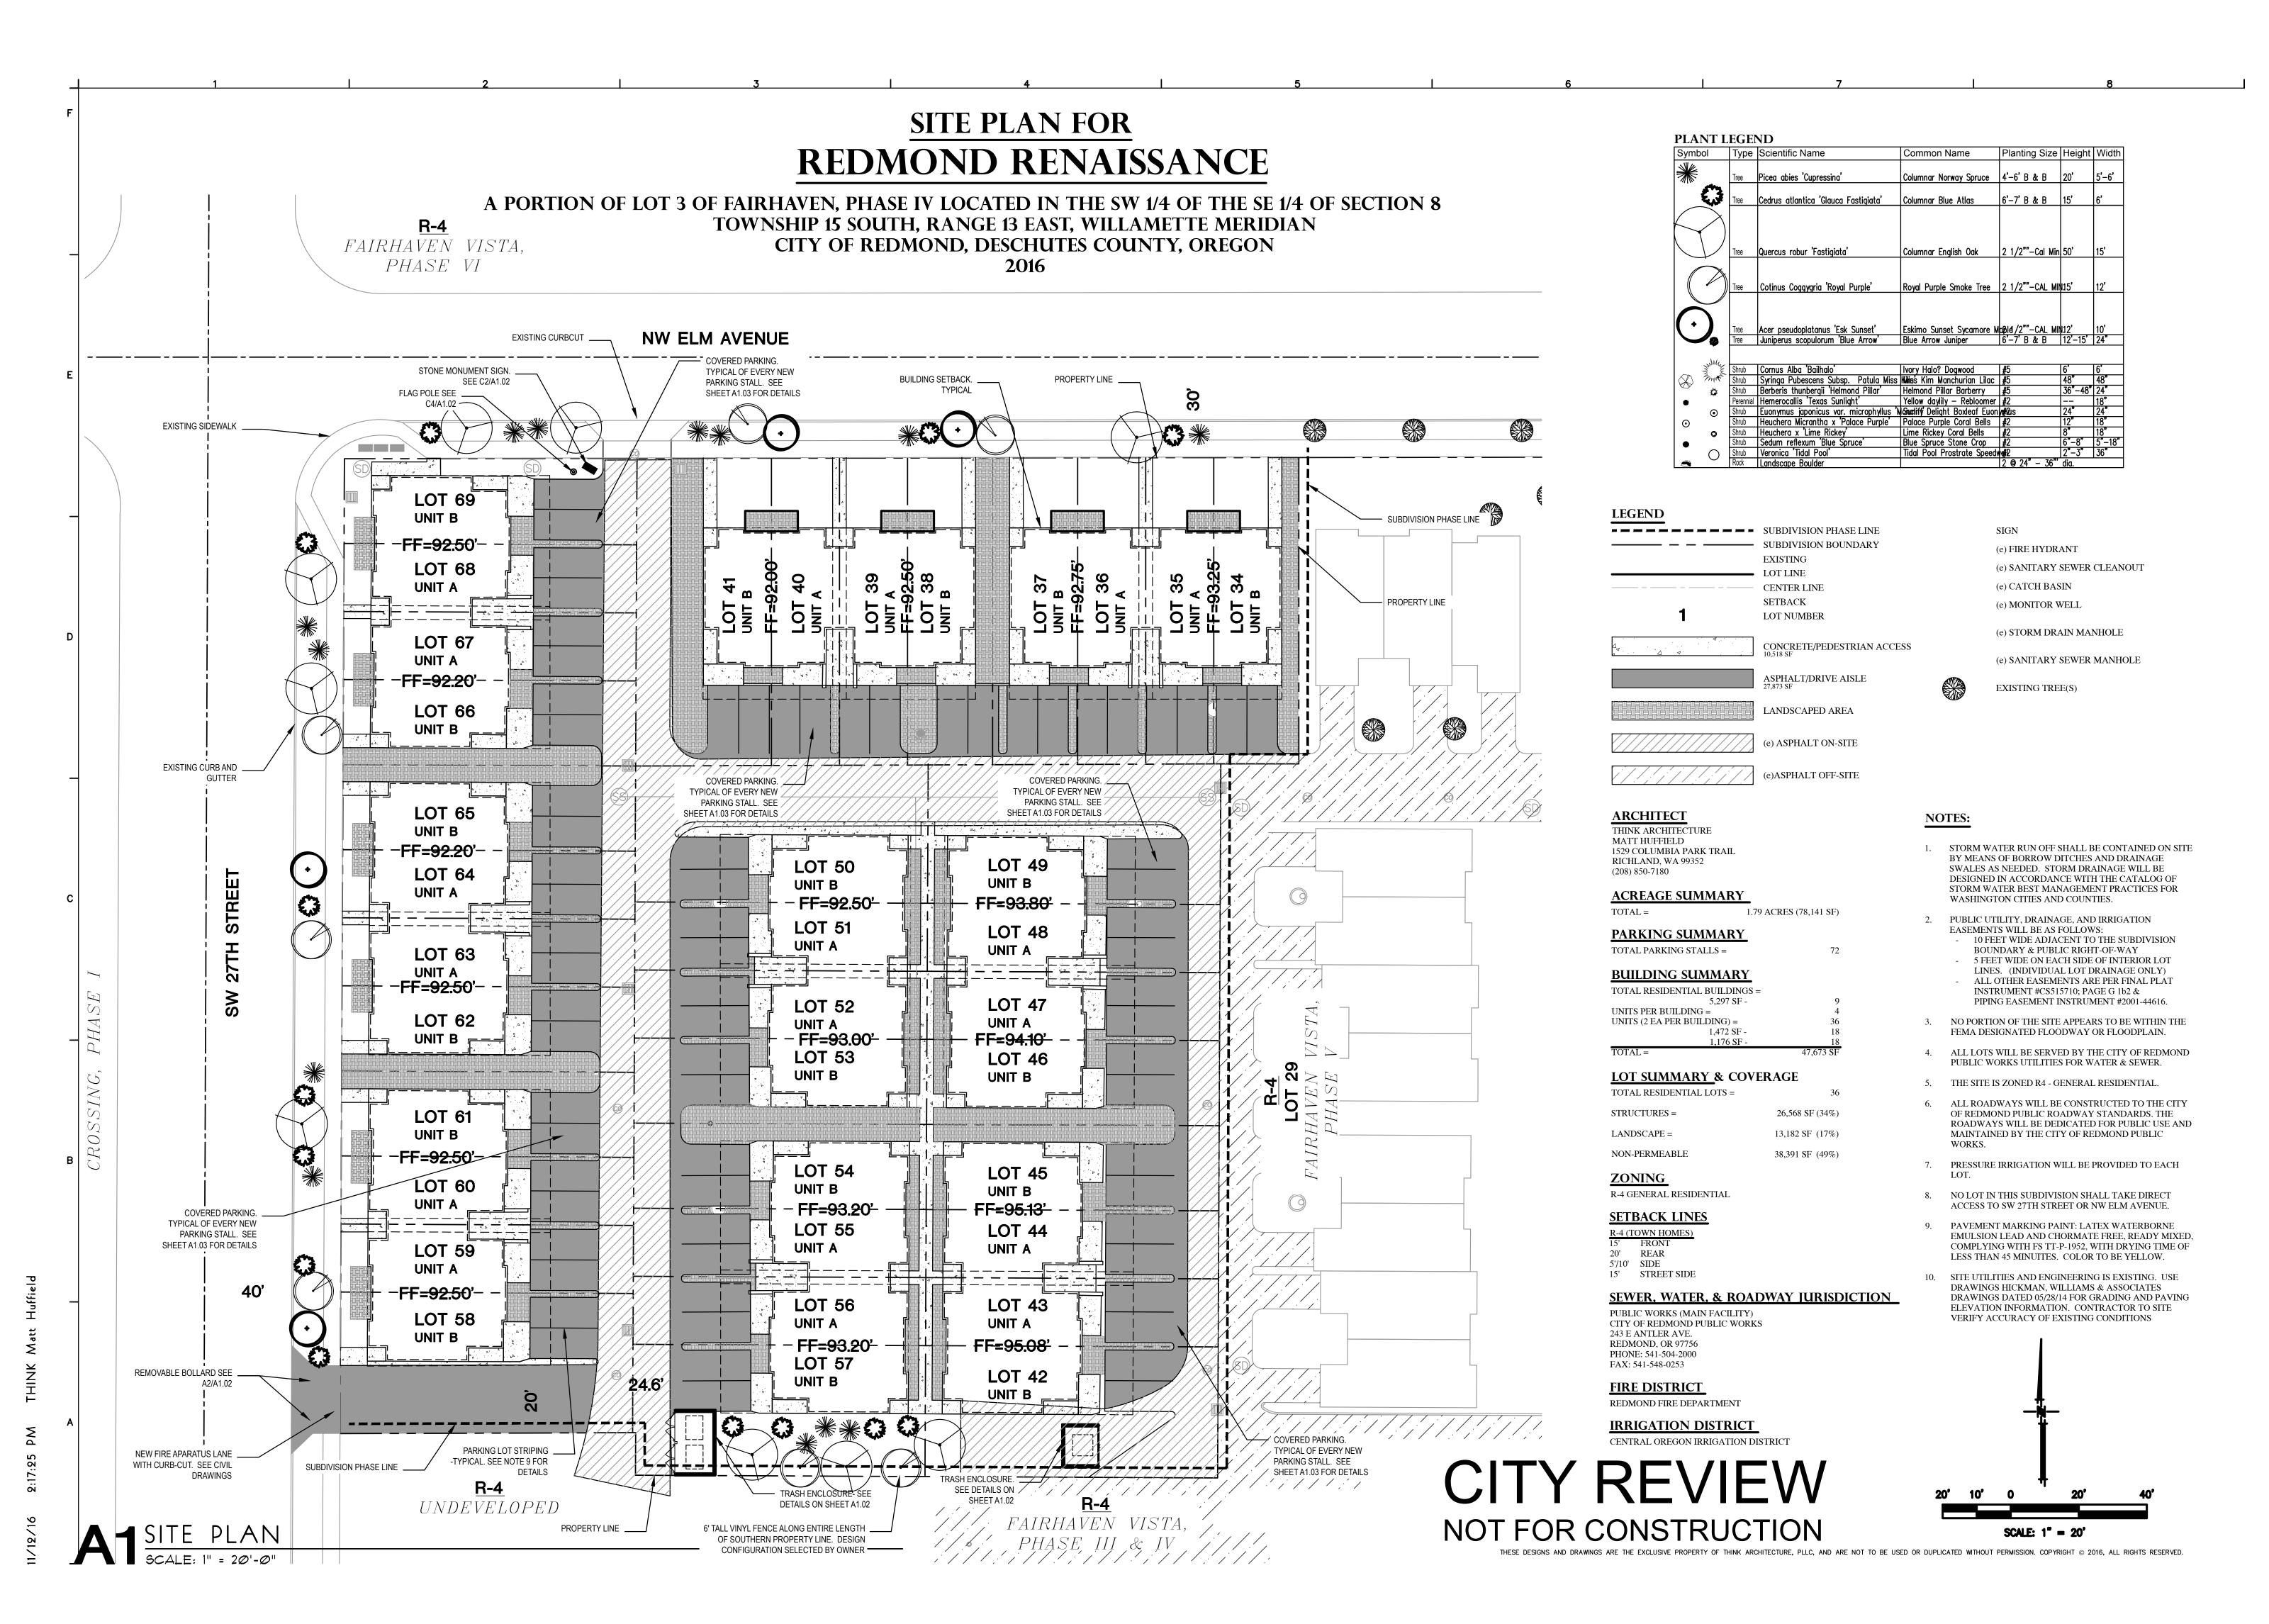



Richland, WA 99352 p: 208.850.7180

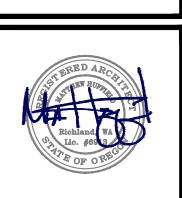

SITE PLAN Sheet Title

AS NOTED

NOVEMBER 8, 2016

1602SHEETSET.DWG

A1.01

- 8" CMU WALL, INTEGRAL COLOR, TO MATCH

BENJAMIN MOORE, HC-169 "COVENTRY

— 8" CMU WALL, SOLID GROUT @ VERTICAL REINFORCING CELLS, TYP.

AS NOTED Project Number


NOVEMBER 8, 2016


1602SHEETSET.DWG


Revisions


A1.02

### CITY REVIEW NOT FOR CONSTRUCTION

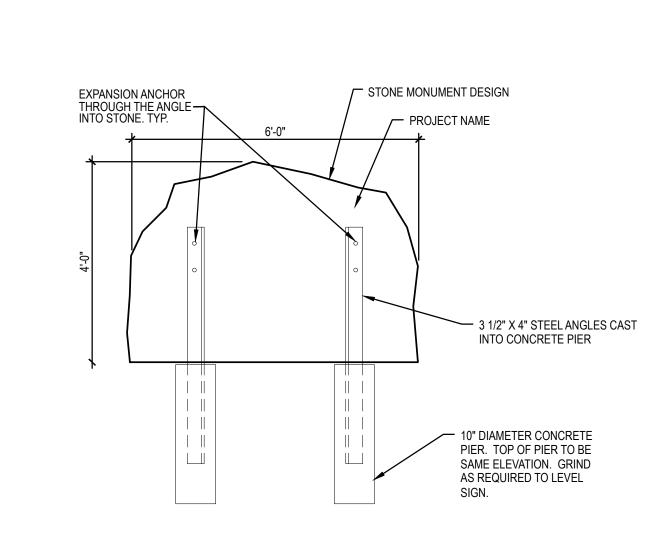

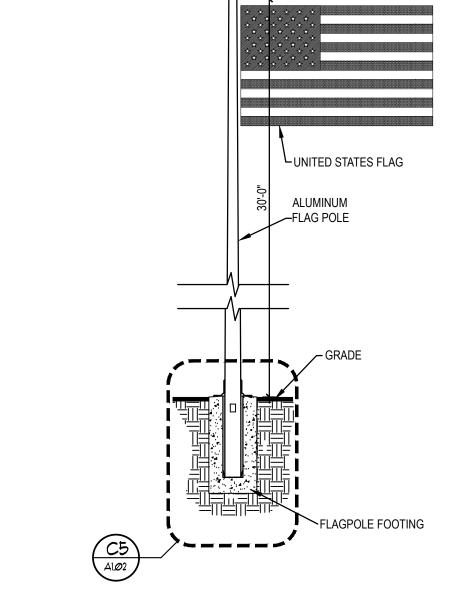

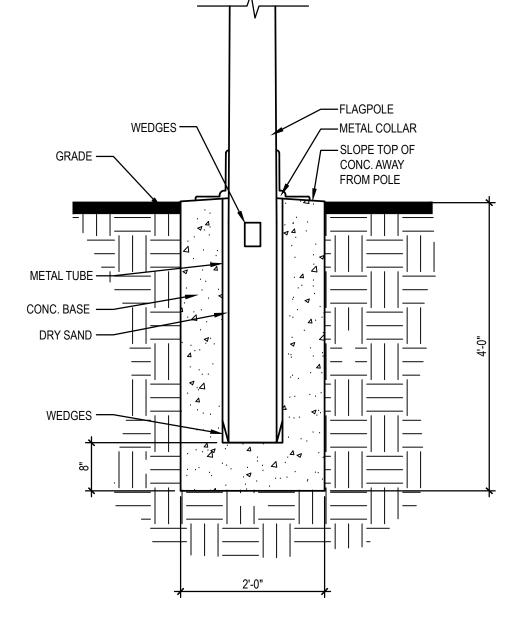

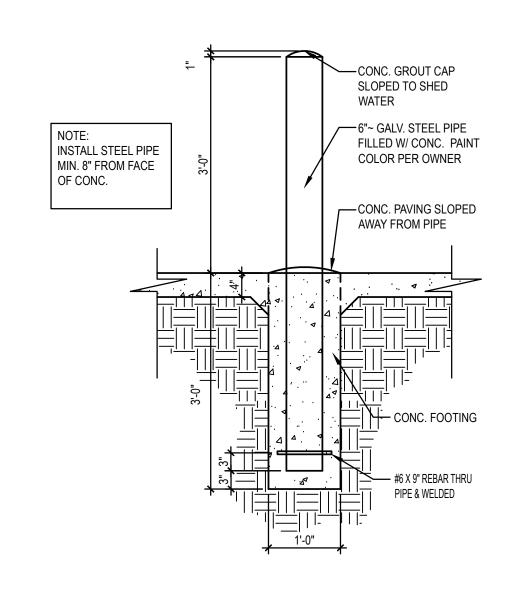

C4 FLAG POLE DETAIL

1/4" = 1'-0"

C5 FLAG POLE BASE DETAIL

3/4" = 1'-0"


 $---- C7 \frac{\text{PIPE BOLLARD DETAIL}}{3/4" = 1'-0"}$ 


COPING W/ CONT. CLEAT EA. SIDE PAINTED TO MATCH CMU


(2) #5 BARS CONT. IN CMU BOND BEAM —

#5 VERTICAL BARS @ 24" O.C. — (DOUBLE BARS AT WALL ENDS

(3) #5 BARS CONT. W/ #5 J-BARS-EA. WAY LAPPING VERTICAL BARS @ 24" O.C.

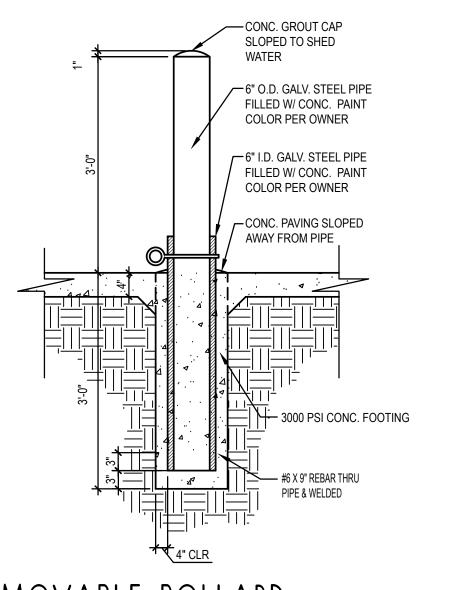


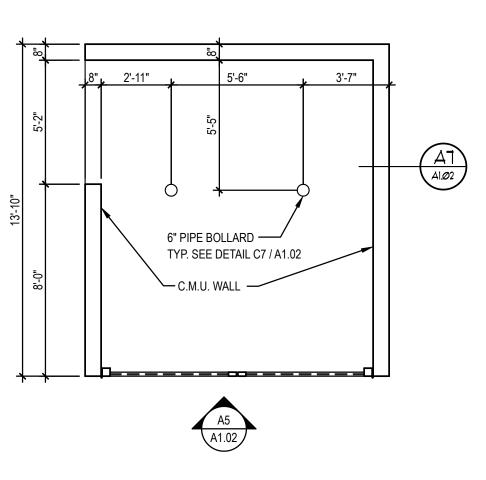

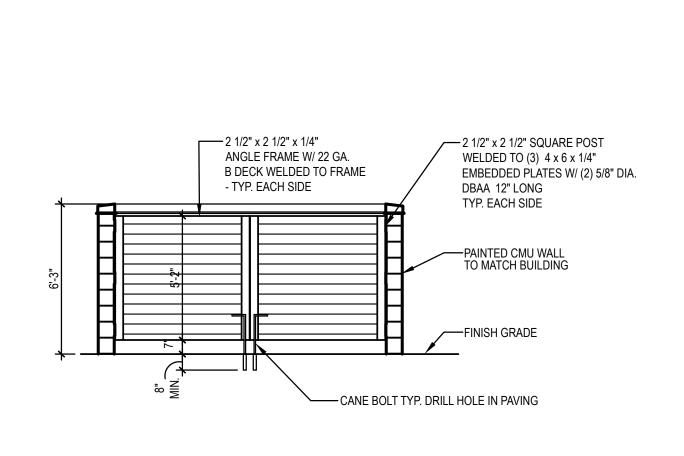





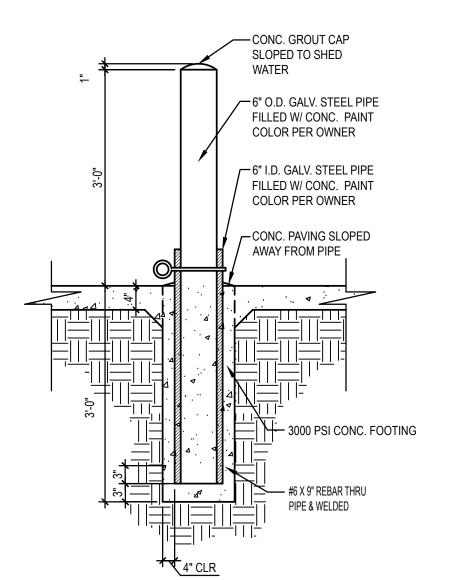

A2 REMOVABLE BOLLARD

1/4" = 1'-0"

The Renassance

C2 STONE MONUMENT SIGN

on Elm


SIGN NOTES:

1) SUBMIT SHOP DRAWINGS FOR APPROVAL OF SIGN DESIGN -SUBMIT COLORS TO MATCH

PROPOSED DESIGN


STONE MONUMENT DESIGN

PROJECT NAME

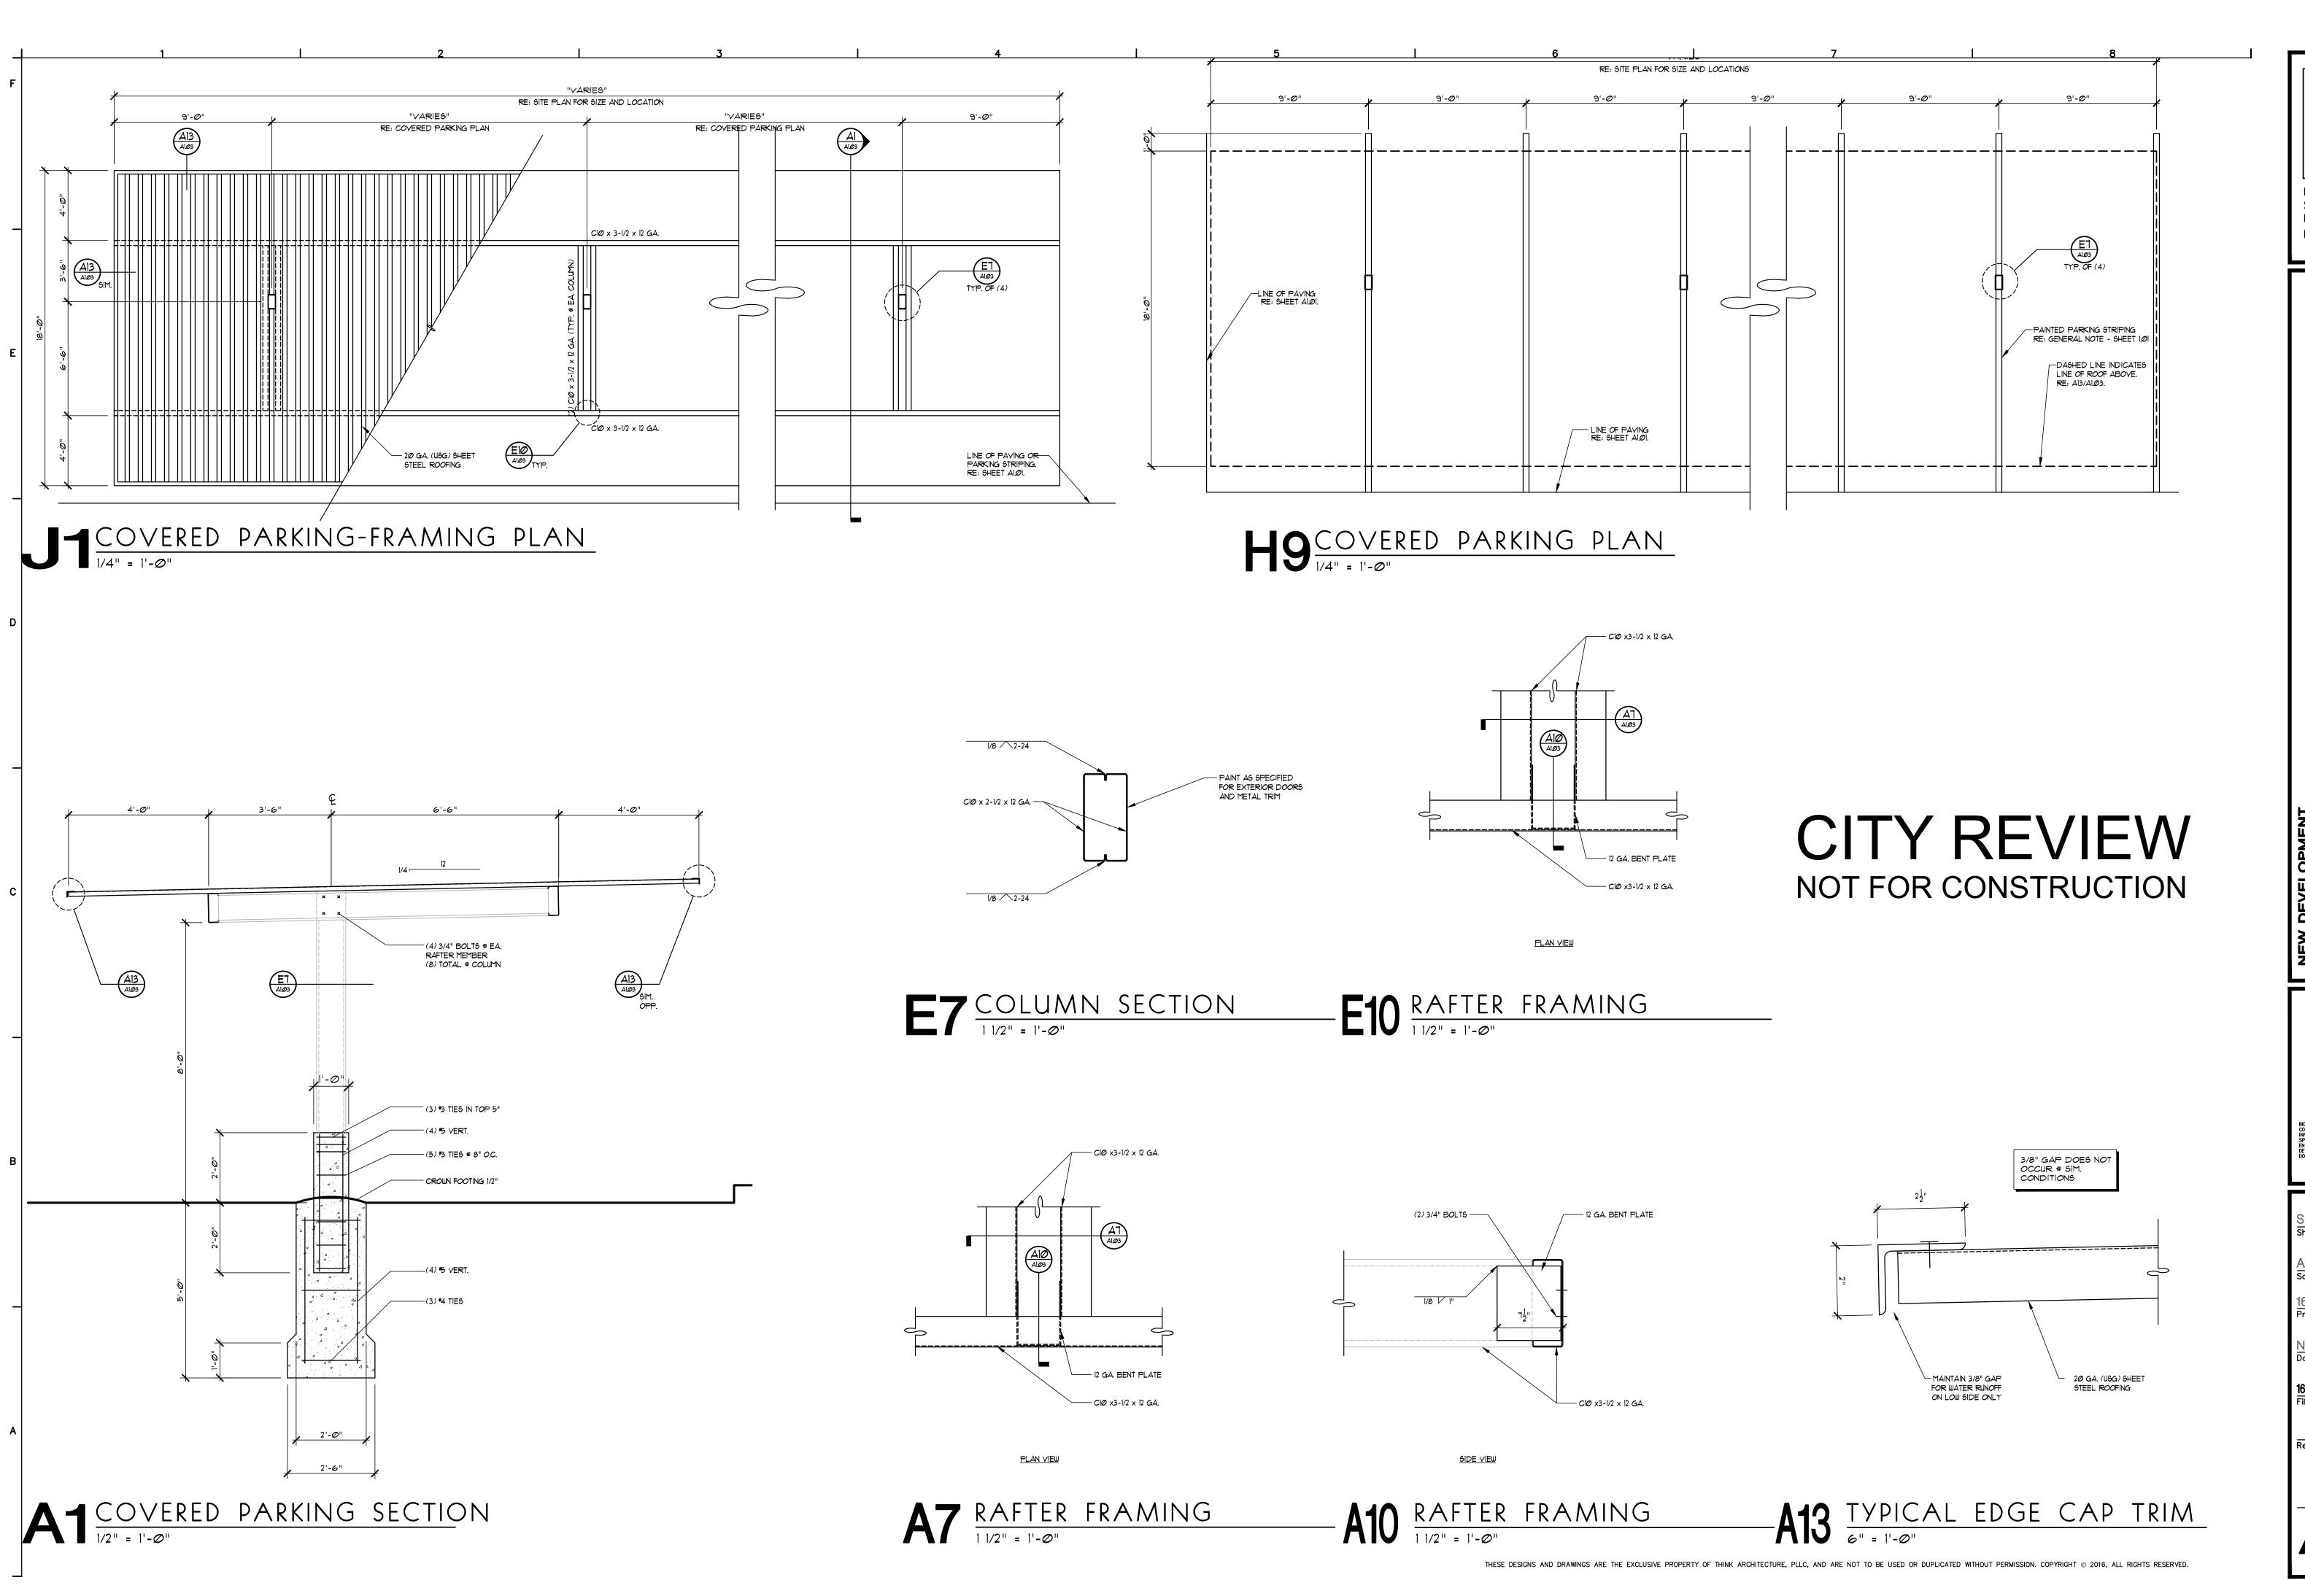

I 529 Columbia Park Trail Suite B312
Richland, WA 99352
p: 208.850.7180

27 ELM TER RENAISSANCE DEVELOPMENT

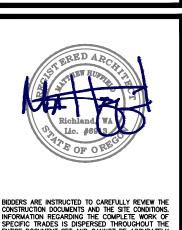

BIDDERS ARE INSTRUCTED TO CAREFULLY REVIEW THE CONSTRUCTION DOCUMENTS AND THE SITE CONDITIONS. INFORMATION RECARDING THE COMPLETE WORK OF SPECIFIC TRADES IS DISPERSED THROUGHOUT THE ENTIRE DOCUMENT SET AND CANNOT BE ACCURATELY DETERMINED BY REFERENCE TO OTHER THAN COMPLETE DOCUMENT SETS.

SITE DETAILS
Sheet Title

AS NOTED
Scale

1602
Project Number

NOVEMBER 8, 2016
Date

1602SHEETSET.DWG
File Name


A1.03

SECOND OVERALL FLOOR PLAN

SCALE: 1/8" = 1'-0"


FIRST FLOOR PLAN

SCALE: 1/8" = 1'-0"

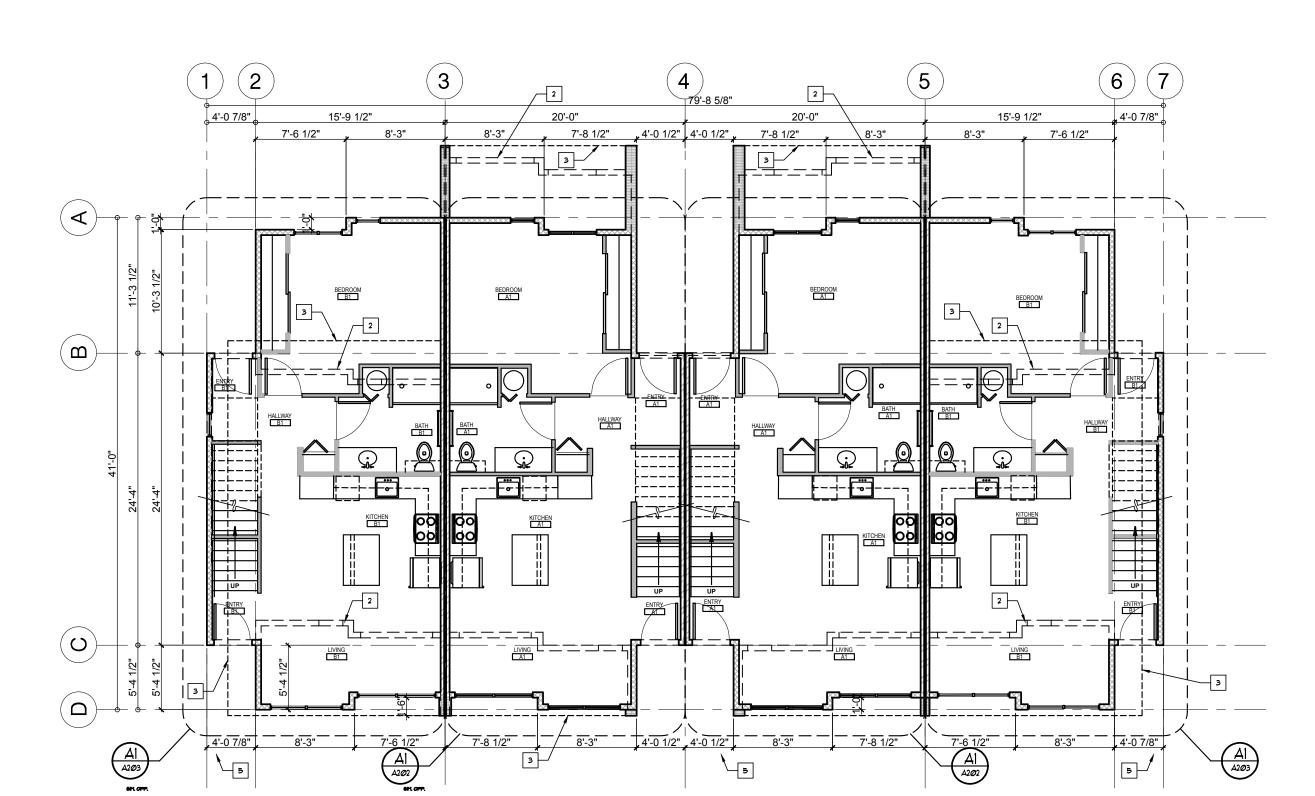

2 X WALL -PER PLANS - WALL SHEATHING — WATER RESISTANT BARRIER FIBER CEMENT SIDING - EzvCORNER EBC27 CAVITY CORNER BLOCKING WITH CAVITY BATTENS SPACED PER MANUFACTURERS RECOMMENDATION HARDIE PANEL SMOOTH WITH MITERED CORNERS EXPANSION GAP AS REQUIRED BY MANUFACTURER \_\_\_\_\_ 1X CAVITY BATTENS SPACED BLOCKING AS REQUIRED — PER MANUFACTURER'S BY MANUFACTURER

RECOMMENDATIONS

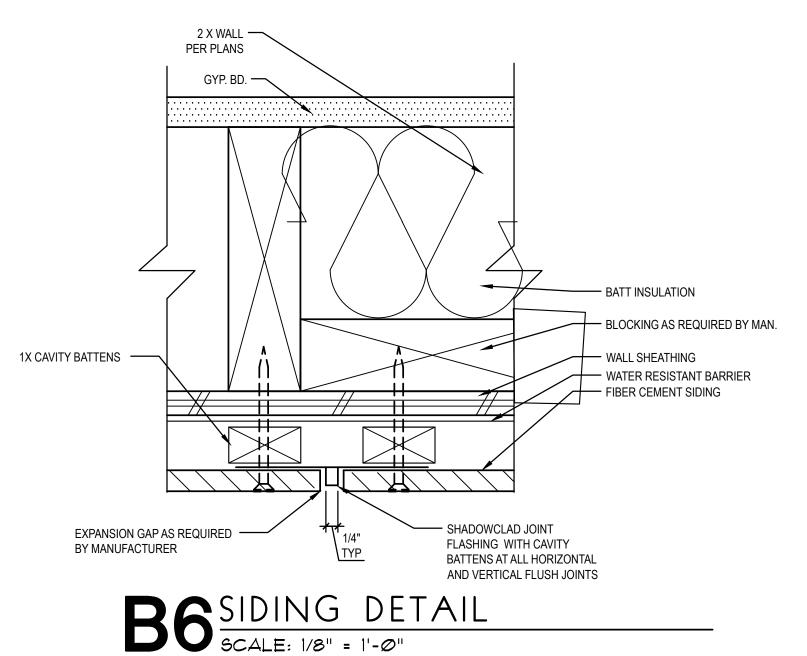

UNLESS NOTED OTHERWISE.

SEE 46.01 FOR WINDOW, DOOR, AND FRAME TYPES. SEE I - SERIES FOR FINISH PLANS AND SCHEDULES

. CONTRACTOR SHALL VERIFY CONDITIONS AND REPORT ANY DISCREPANCIES WITH THE DRAWINGS TO THE ARCHITECT PRIOR TO THE BEGINNING OF WORK.

CONTRACTOR TO MAINTAIN BUILDING IN A WEATHER TIGHT CONDITION DURING INSTALLATION OF FINISH

CONTRACTOR TO COORDINATE WITH OWNER FOR LOCATION OF ALL SPECIAL EQUIPMENT AND SPECIAL POWER REQUIREMENTS.

ALL FIXTURES AND EQUIPMENT TO BE INSTALLED OR REINSTALLED, ARE TO BE SO IN ACCORDANCE WITH THE MANUFACTURERS REQUIREMENTS, ACCEPTED BUILDING STANDARDS AND ALL APPLICABLE BUILDING CODES.

10. DOORS TO BE INSTALLED 4" FROM ADJACENT WALL

CITY REVIEW NOT FOR CONSTRUCTION

WALL TYPE SCHEDULE

WALL TYPE 1 - UL U339/U341 1-HOUR RATED PARTITION WALL DOUBLE 2X4 STUDS @ 16" O.C. W/ I" AIR GAP BETWEEN AND TWO LAYERS %" TYPE "X" GYP. BOARD EACH SIDE TO TOP OF STRUCTURE. RE: PLANS

> WALL TYPE 2 - RATED PARTITION WALL DOUBLE 2X4 STUDS @ 16" O.C. W/ 1" AIR GAP BETWEEN AND 1 APA RATED SHEETHING OVER TWO LAYERS 1/8" TYPE "X" GYP. BOARD EACH SIDE TO TOP OF STRUCTURE. RE: PLANS

EXTERIOR SIDING W/ 1/2" APA RATED SHEATHING OVER DOUBLE 2X4 STUDS @ 16"

2X4 STUDS @ 16" O.C. W/ ONE LAYER 1/2" TYPE GYP. BOARD EACH SIDE TO 6" ABOVE ADJACENT CEILING. 2X6 STUDS @ 16" O.C. AT PLUMBING WALLS AND WHERE NOTED, RE:

KEY NOTES

LINE OF FLOOR BELOW, RE: STRUCTURAL

2 LINE OF FLOOR ABOVE. 3 LINE OF SOFFIT ABOVE

4 42" HIGH GUARD RAIL RE: AI/AT.ØI

5 CONCRETE PAVING. SEE SITE PLAN.

GENERAL NOTES

ALL DIMENSIONS ARE TO FACE OF PRIMARY STRUCTURAL COMPONENT (STUDS, CONCRETE OR STRUCTURAL GRID) FOR CONSTRUCTION ASSEMBLY

SEE A6.01 FOR DOOR SCHEDULE.

EXIT DOORS TO BE OPERABLE FROM INSIDE WITHOUT A KEY OR SPECIAL KNOWLEDGE IN ACCORDANCE WITH IBC

UNLESS NOTED OTHERWISE.

1529 Columbia Park Trai Suite B312 Richland, WA 99352 p: 208.850.7180

OPMEN EVEL 

FLOOR PLANS Sheet Title


AS NOTED


Project Number

NOVEMBER 8, 2016

1602SHEETSET.DWG

**A2.01** 

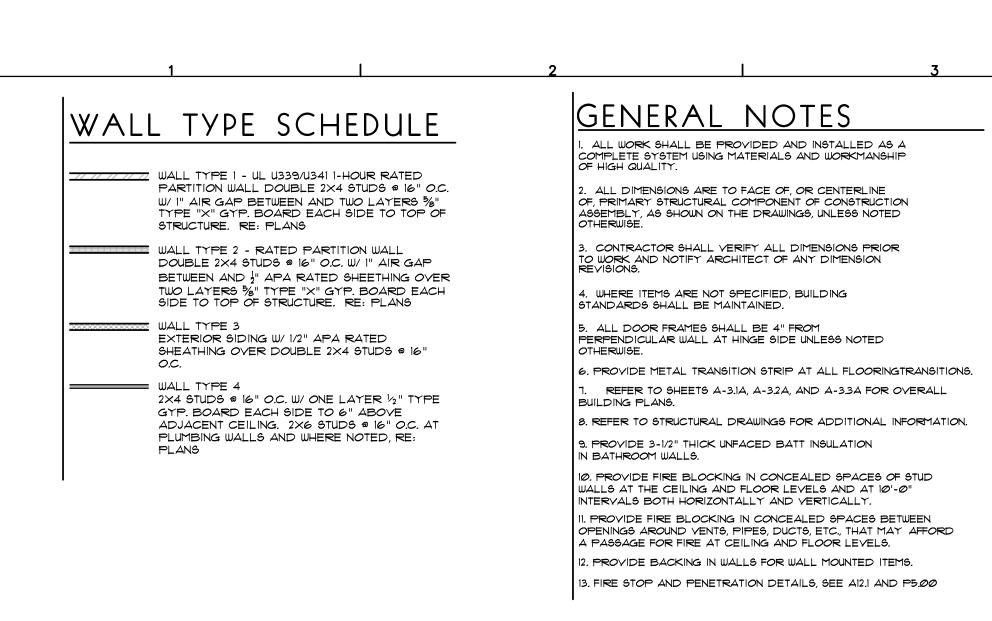

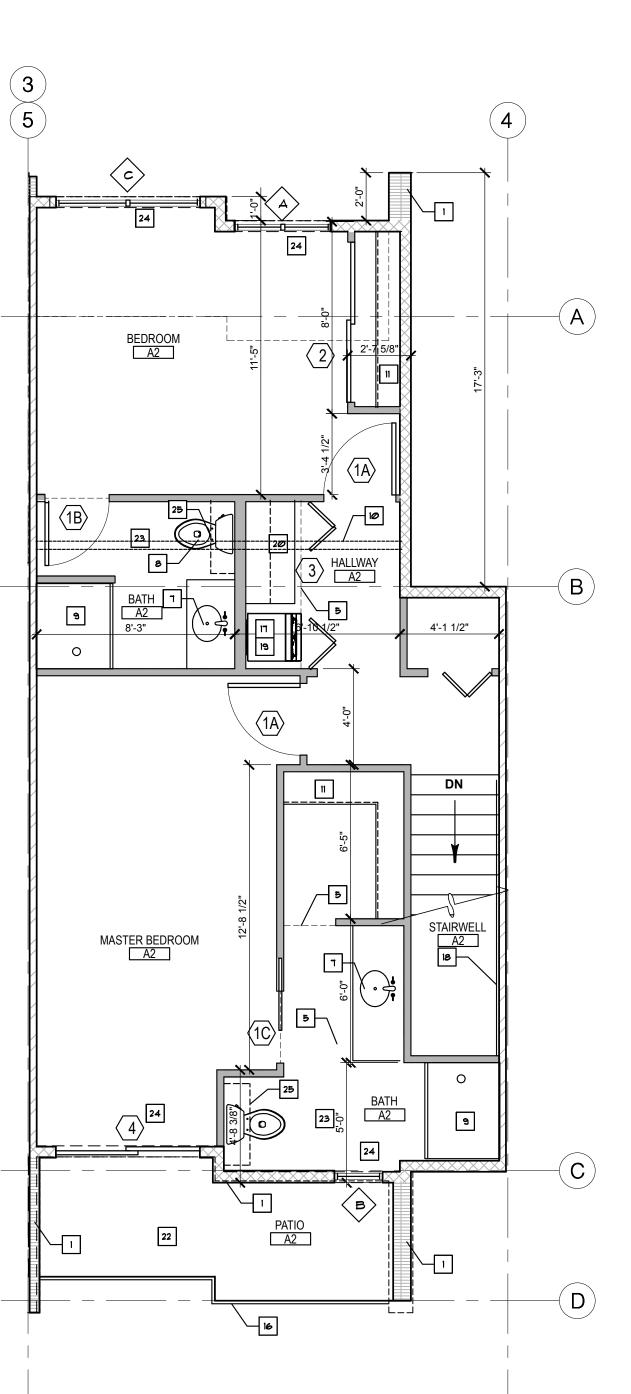

KEYED NOTES

3 LINE OF STRUCTURE ABOVE.

5 FLOORING TYPE TRANSITION.

6 WATER HEATER, RE: PLUMBING

8 WATER CLOSET, RE: PLUMBING

10 PARTITION WALL AT PLANT SHELF.

ROD AND SHELF. RE: A12/A5.10

RANGE WITH MICROWAVE HOOD

15 UNDER-COUNTER DISH WASHER

16 42" HIGH GUARDRAIL AT SECOND LEVEL RE: ELEVATIONS AND DETAILS

14 REFR/FREEZER

COUNTER SET SINK W/ DISPOSAL, RE: PLUMBING

4 LINE OF 2×4 WALL BELOW COUNTER

COUNTER SET SINK, RE: PLUMBING

2X6 FRAMING ® 16" OC TYPICAL ® EXTERIOR WALL\$ 4 Interior Plumbing Wall\$ UN.O. RE: \$Tructural

2 2X4 FRAMING @ 16" OC TYPICAL @ INTERIOR WALLS, UN.O., RE: STRUCTURAL FOR LOAD BEARING LOCATIONS

9 SHOWER WITH THE FOLLOWING:
36"X48" SWANSTONE SHOWER SURROUND (\*132 IVORY GLASS)
SWANSTONE SHOWER BASE (\*124 CANYON)
FRAMELESS HINGED GLASS SHOWER DOOR WITH POLISHED
CHROME HARDWARE.

17 STACKABLE WASHER/DRYER UNIT.

26 LINE OF STAIRS ABOVE

28 LINE OF FLOOR BELOW.

18 HANDRAIL AT 34"-38" A.F.F., SLOPE TO FOLLOW STAIR. SEE AT/AT.Ø1

20 INSTALL (5) 24" DEEP WIRE OR MELAMINE SHELVES WITH EDGE TRIM.

9LOPE EXTERIOR PATIO SUBSTRATE FOR POSITIVE DRAINAGE AWAY FROM WALL FLASHING.

TOILET ACCESSORIES - TAYMOR ZURICH WITH US26D FINISH, PROVIDE BLOCKING AS REQUIRED.
-24" TOWEL BAR
-TOWEL RING
-ROBE HOOK
-PAPER HOLDER

WINDOW TREATMENT: 2" METAL VENETIAN BLINDS, COLOR AND MODEL SELECTED BY OWNER.


25 CASEWORK, RE: A5ØI INTERIOR ELEVATIONS, A5.11 CASEWORK DETAILS, AND A6ØI FINISH SCHEDULE FOR ADDITIONAL INFORMATION.


19 WASHER/DRYER HOOKUP, RE: ELECTRICAL & PLUMBING


21 ELECTRICAL PANEL. RE: ELECTRICAL DRAWINGS

27 CONDENSING UNIT ON ROOF. SEE MECHANICAL.



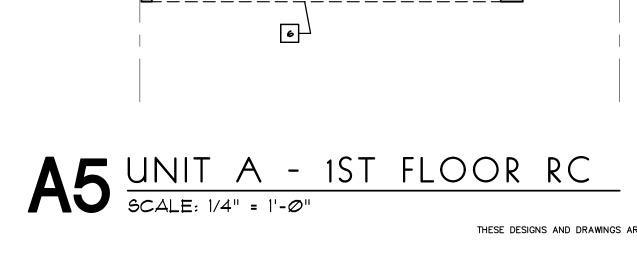

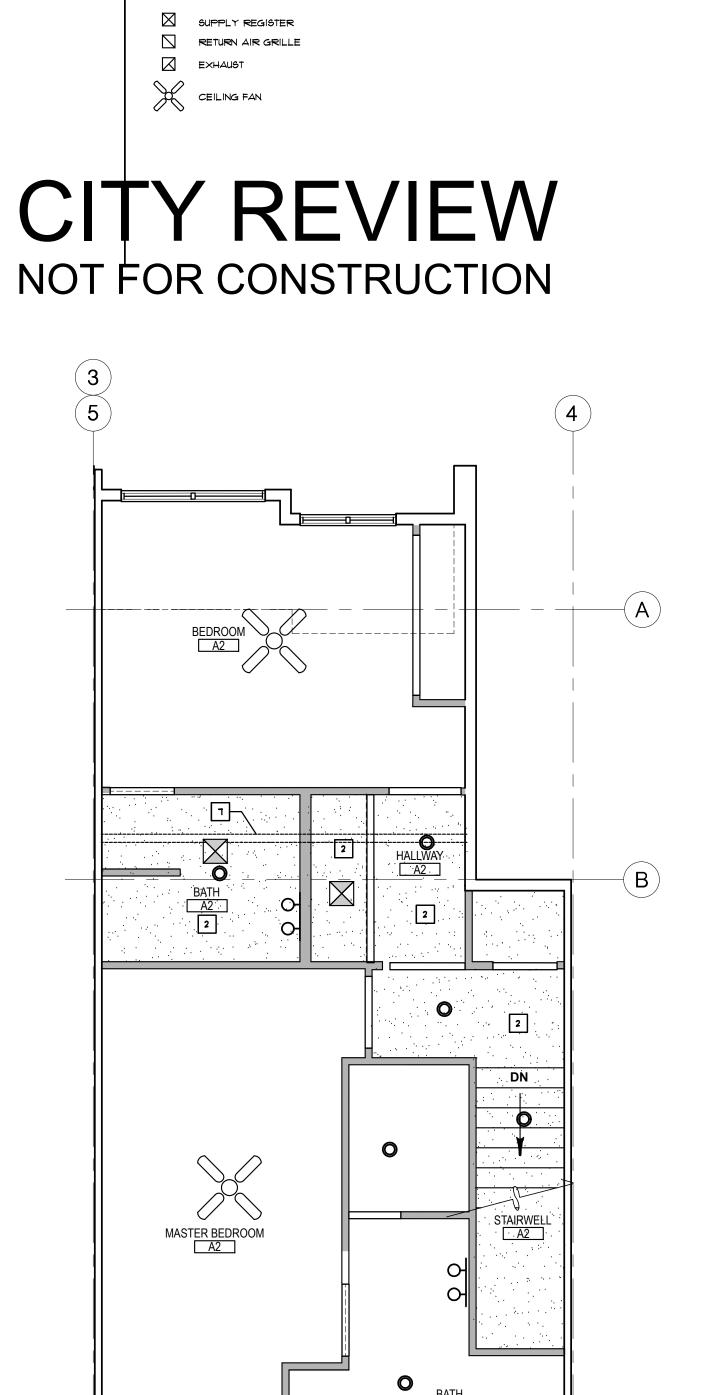

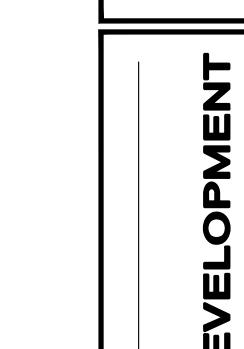

ARCHITECTU

1529 Columbia Park Tra

Richland, WA 99352

p: 208.850.7180

Suite B312



FLOOR PLANS AS NOTED NOVEMBER 8, 2016

1602SHEETSET.DWG

A2.02

A7 UNIT A - 2ND FLOOR RC

A1 UNIT A - FIRST FLOOR

SCALE: 1/4" = 1'-0"

ATTACHED TO B.O. FRAMING

1/2" GYP. BD FURRED BELOW SUSPENDED CEILING AT 8'-0" AFF. ATTACHED TO TRACK FRAMING. PROVIDE RECESSES IN LOCATIONS PROVIDE RECESSES IN LOCATIONS AS SHOWN ON PLAN.

- INCANDESCENT

HO SCONCE

4' WALL MOUNTED FIXTURE

2' WALL MOUNTED FIXTURE

WHERE NO CLNG PATTERN IS SHOWN. (1) LATER 1/2" GYP. BD. ATTACHED TO B.O. STRUCTURAL JOISTS OR TRUSSES.

RC PLAN LEGEND

------BATH A1

RC PLAN KEYED NOTES

DRAWINGS.

8 NOT USED

6 OUTLINE OF STRUCTURE ABOVE.

7 PARTITION WALL AT PLANT SHELF


FURRING OVER CABINETRY W/ 1/2" GYP. BRD. SEE BUILDING AND WALL SECTIONS.

(1) LAYER 1/2" GYP, BRD, CEILING AT 8'-0" AFF, ON FURRING, SEE BUILDING AND WALL SECTIONS FOR FIRE RATED ASSEMBLIES.

4 PERFORATED PREFINISHED METAL SOFFIT PANEL SLIPPED UNDER METAL FASCIA.

5 PREFINISHED METAL GUTTER. SEE ALSO ROOF PLAN AND EXTERIOR ELEVATIONS

1/2" GYP. BRD. ENCLOSURE AT HVAC DUCT AND SOFFITS. RE: MECHANICAL

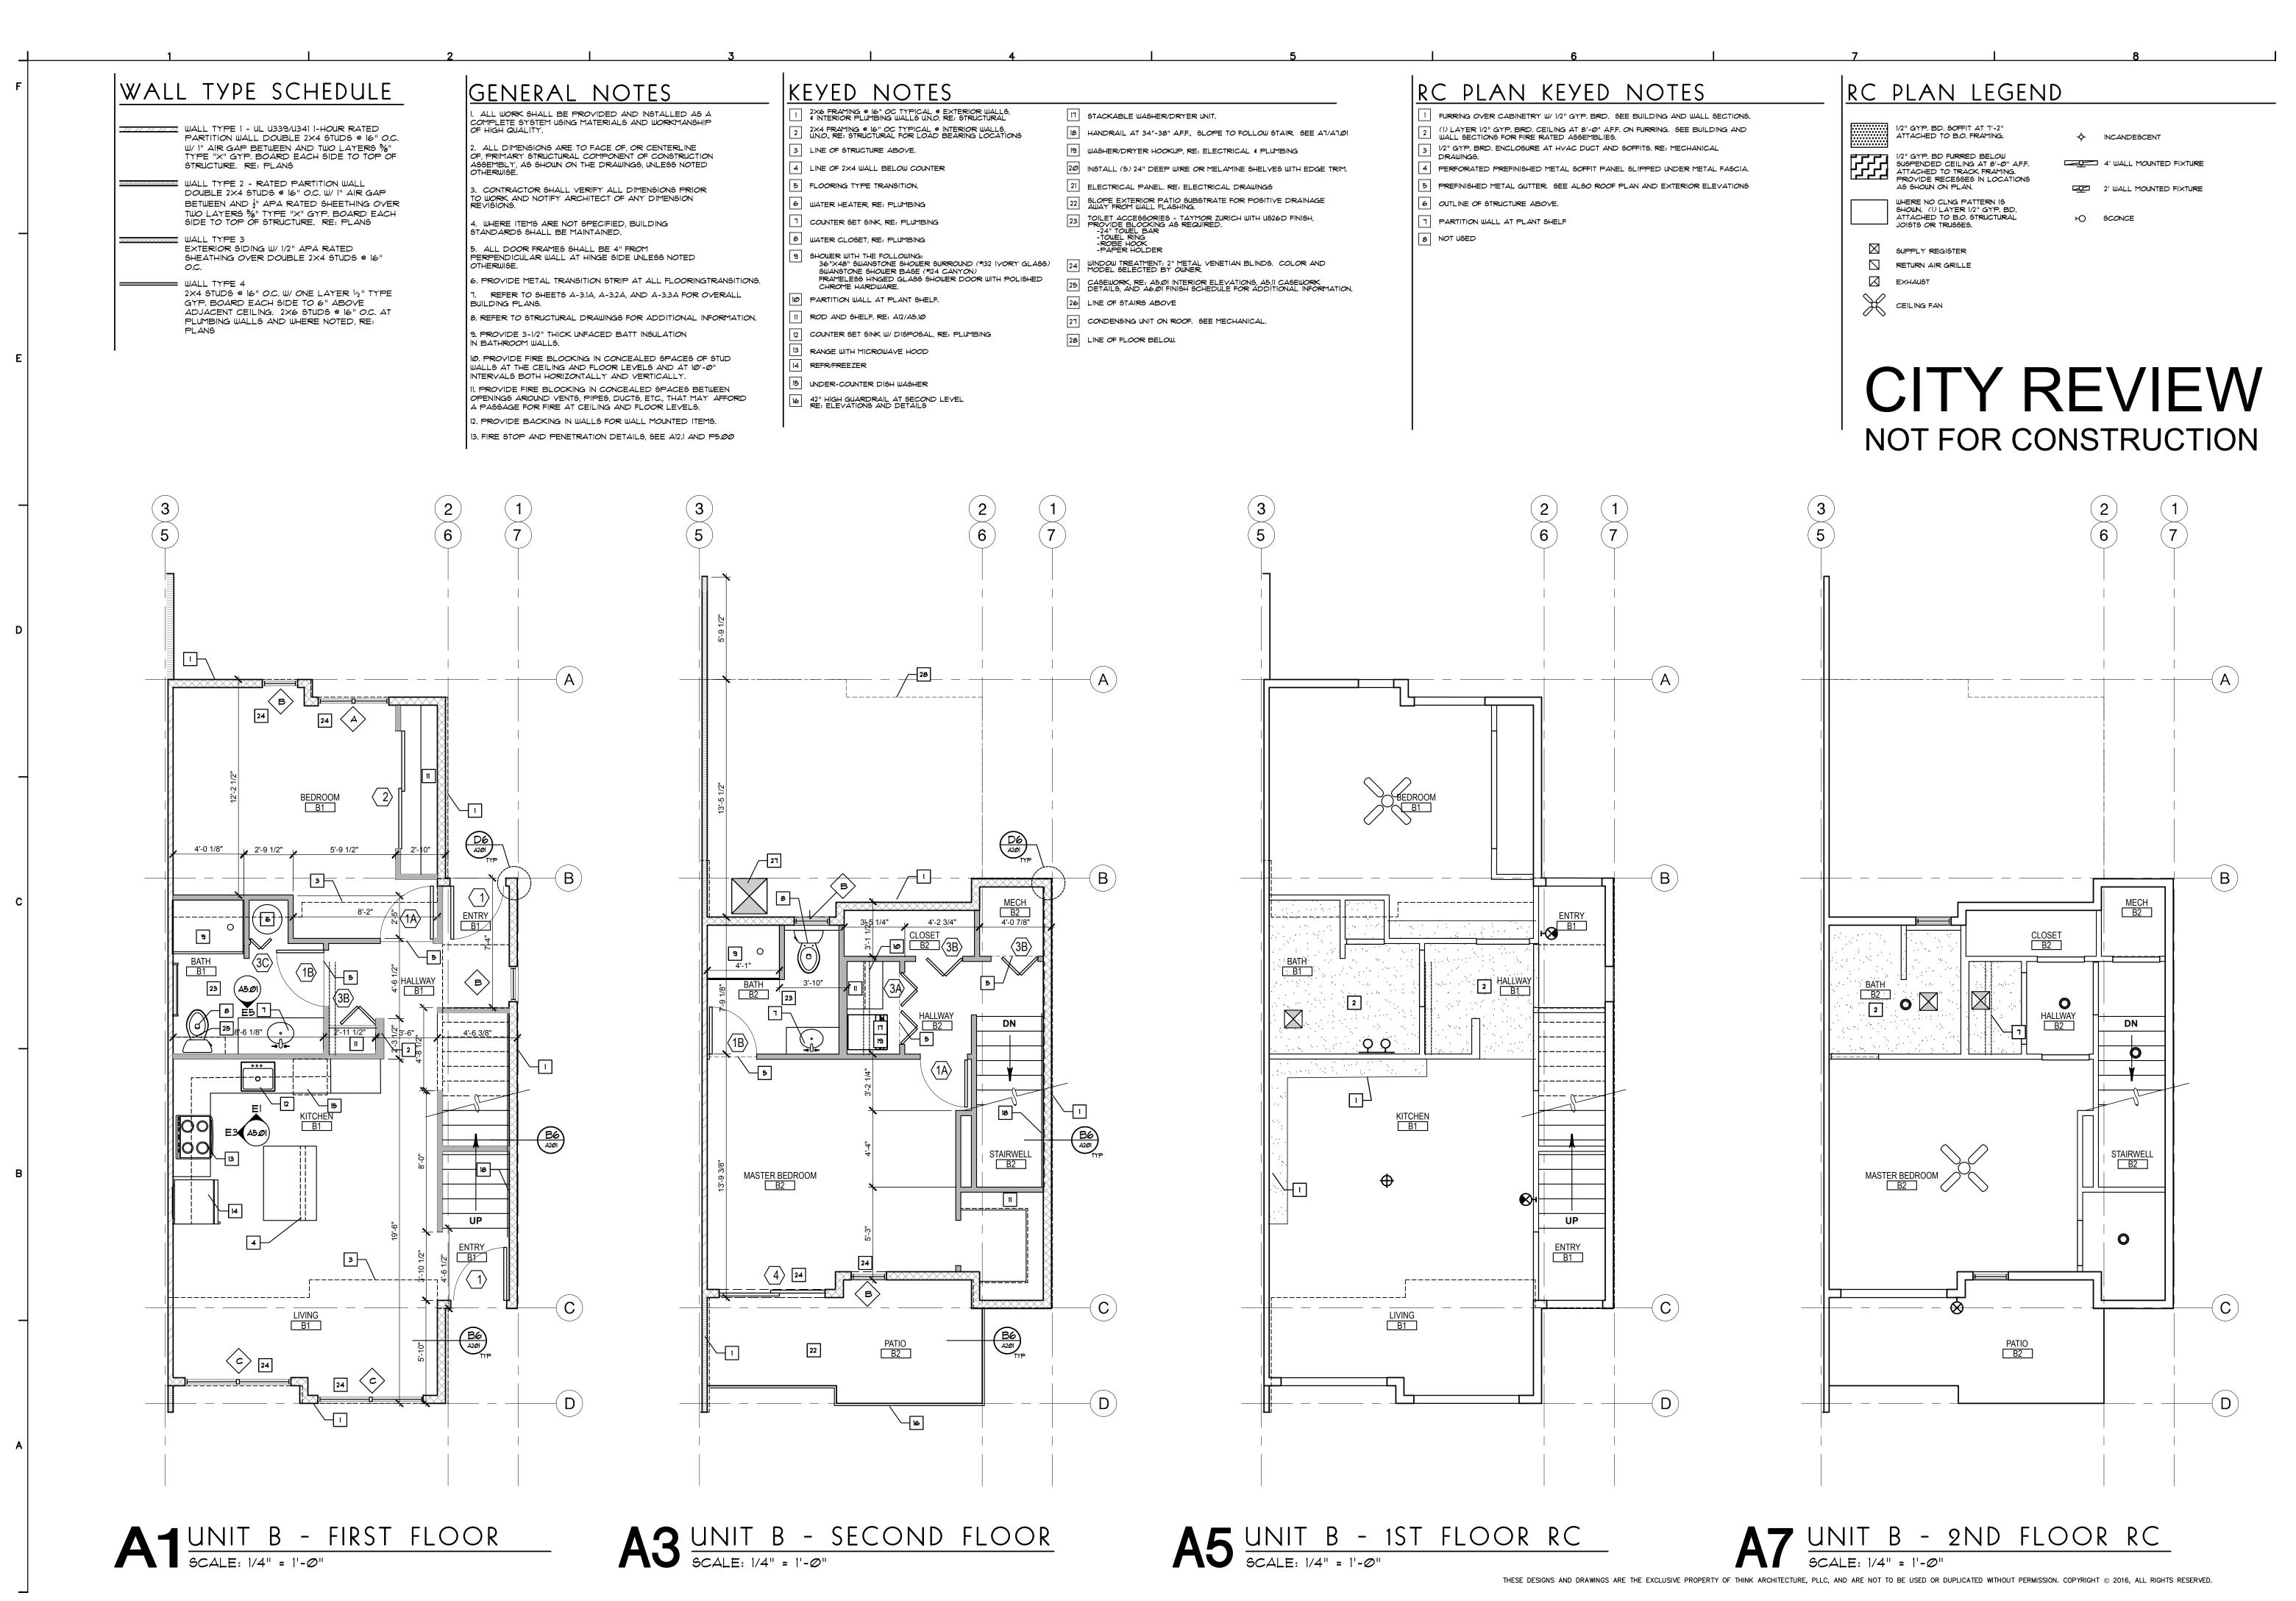

ARCHITECTU 1529 Columbia Park Tra Suite B312 Richland, WA 99352

p: 208.850.7180

O

Ш AISS,




FLOOR PLANS

AS NOTED

NOVEMBER 8, 2016

1602SHEETSET.DWG

A2.03

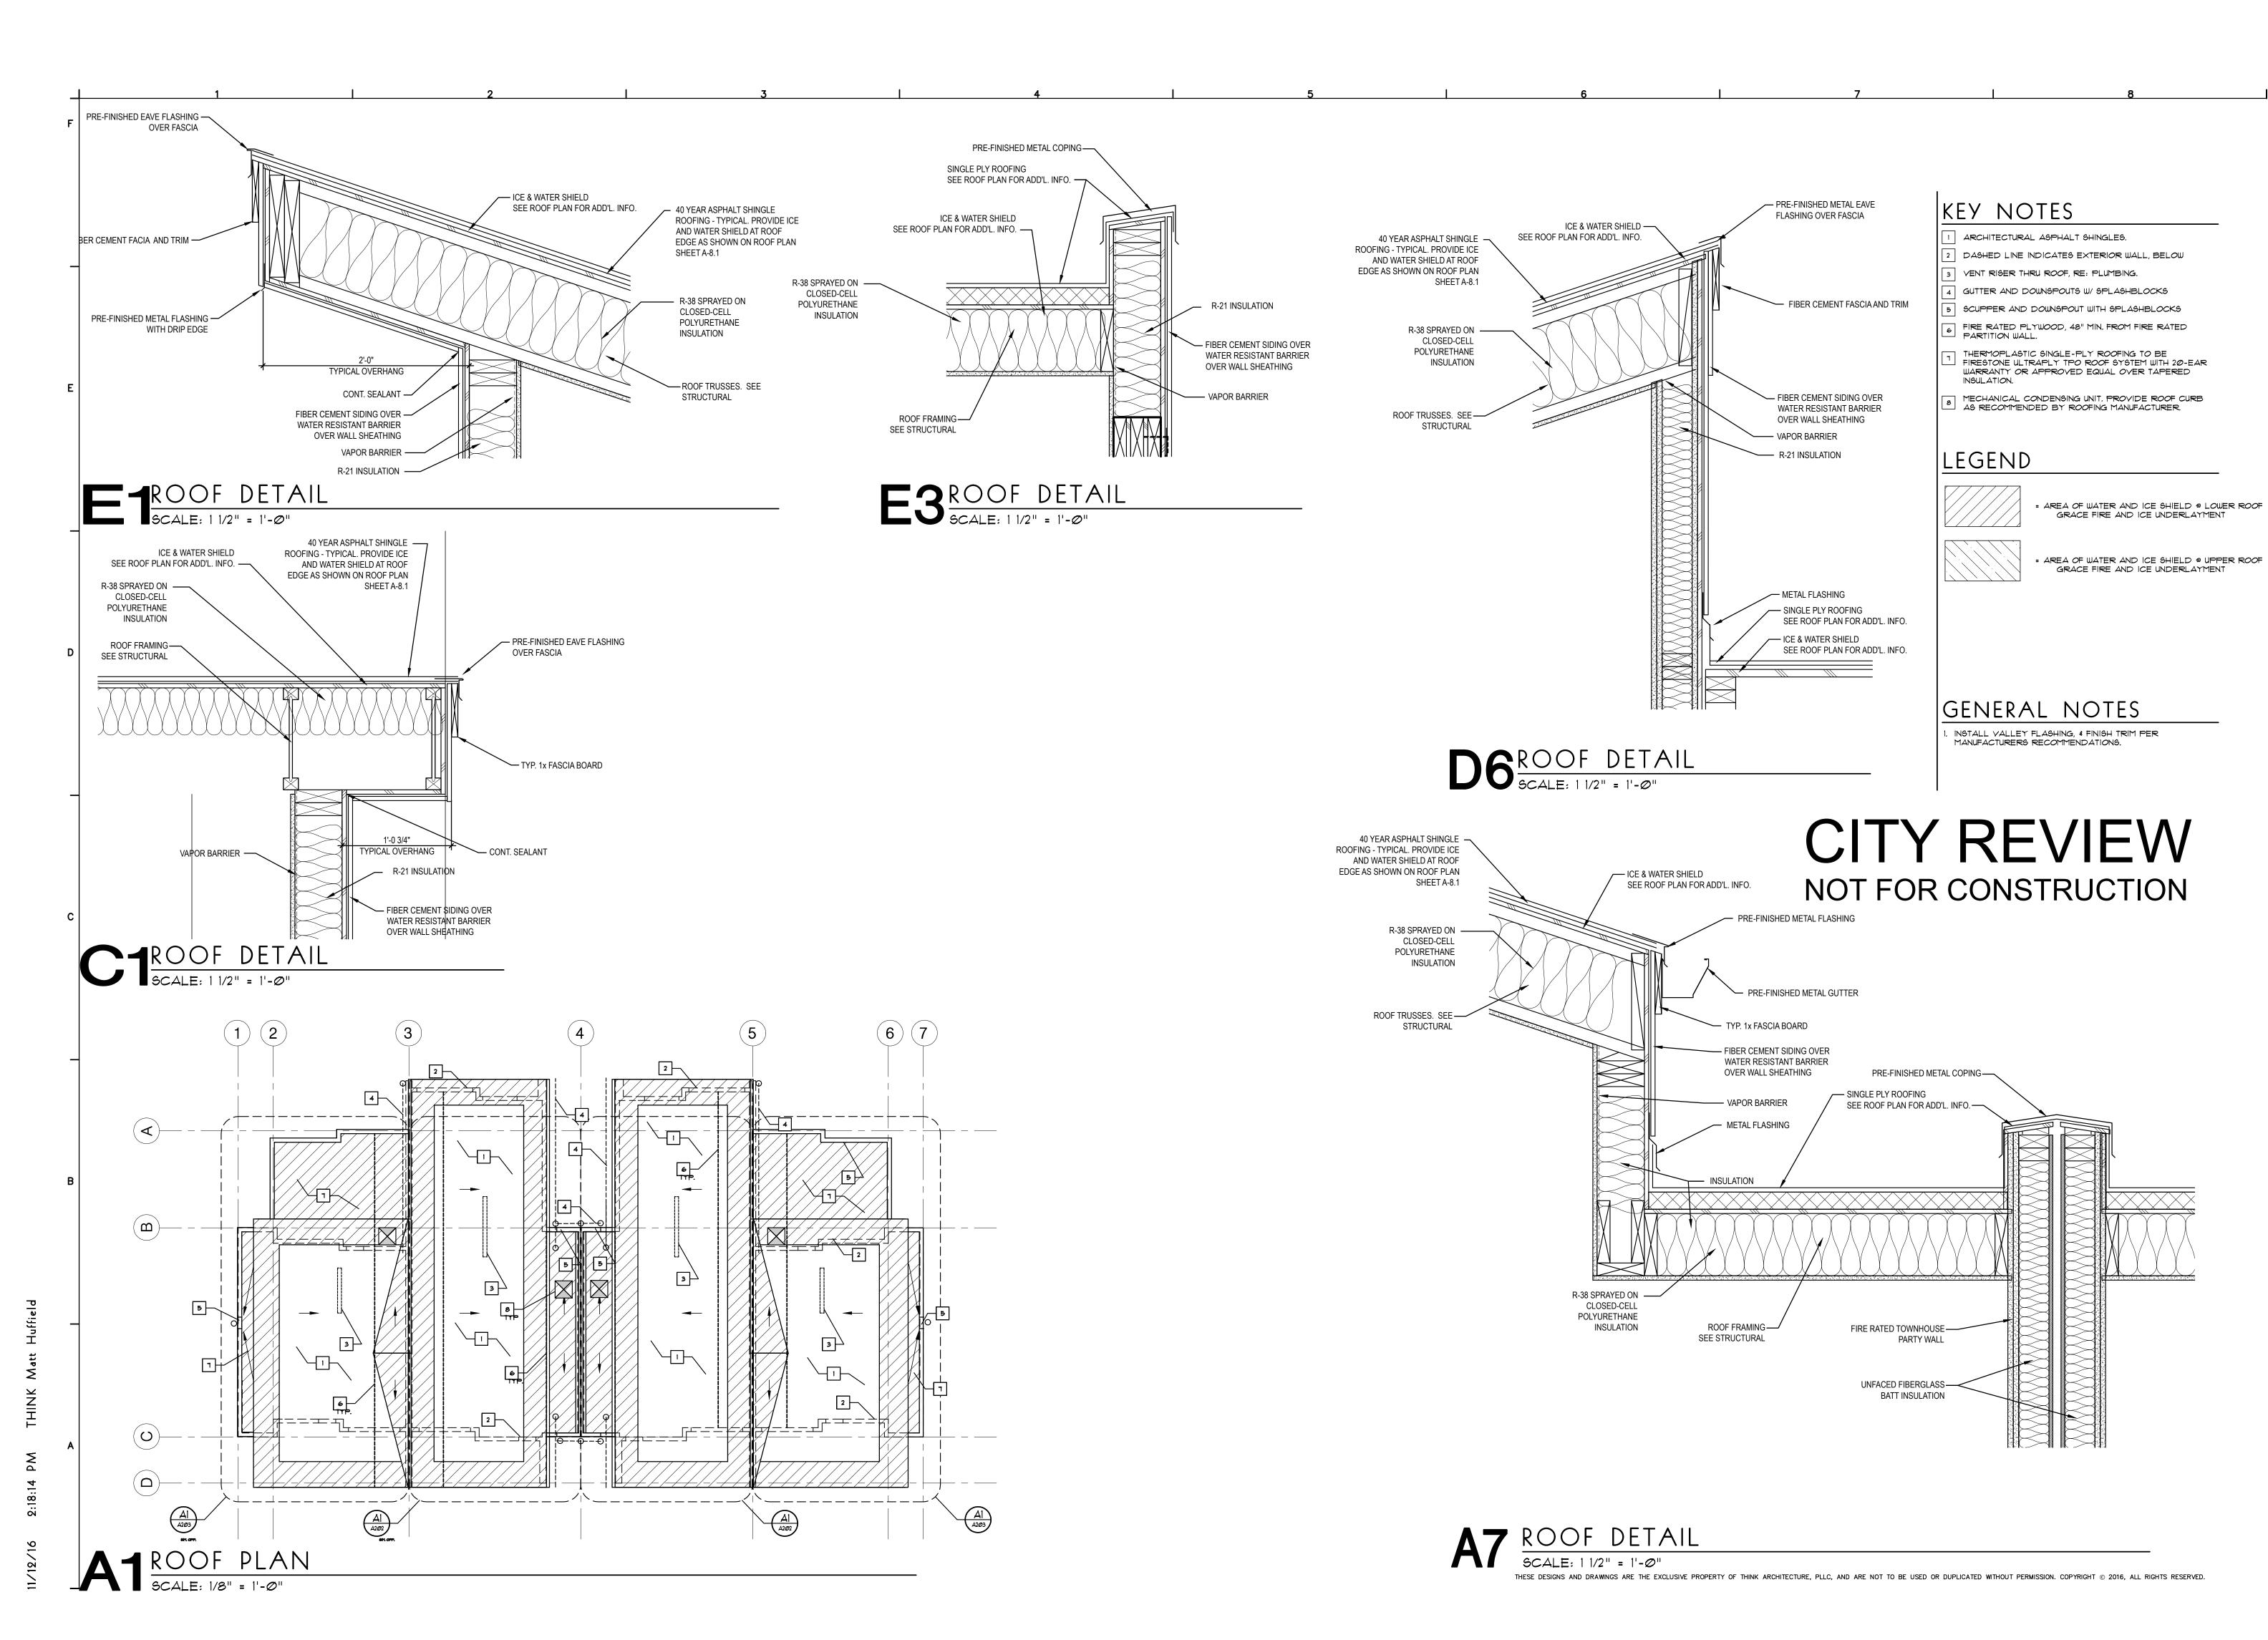



Richland, WA 99352 p: 208.850.7180


ROOF PLAN Sheet Title AS NOTED

Project Number


NOVEMBER 8, 2016

1602SHEETSET.DWG

**A2.11** 

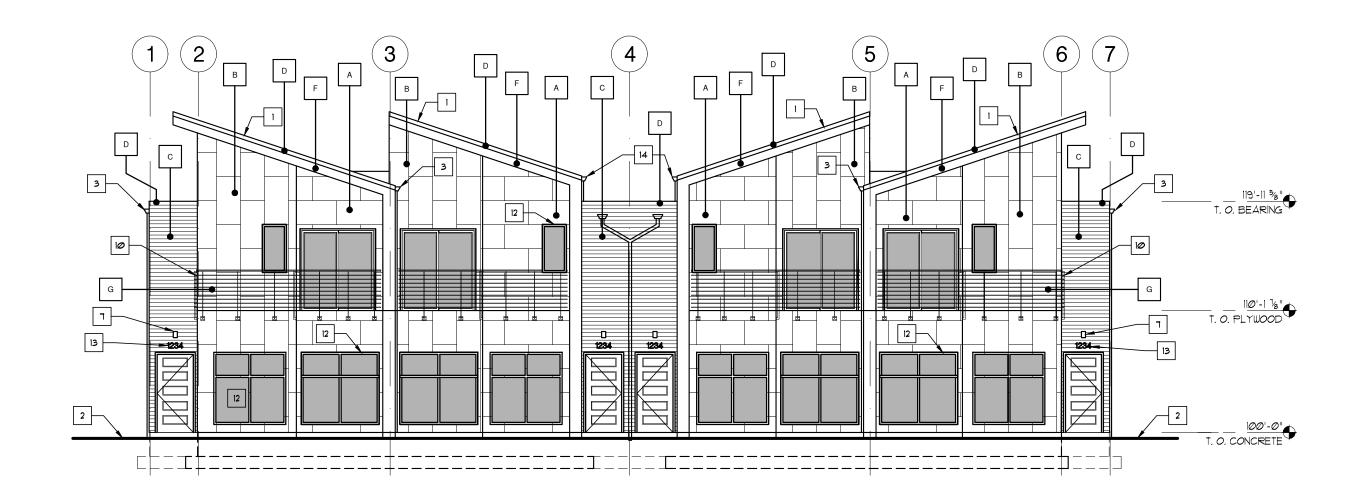


### EXTERIOR ELEVATION SCALE: 1/8" = 1'-0"

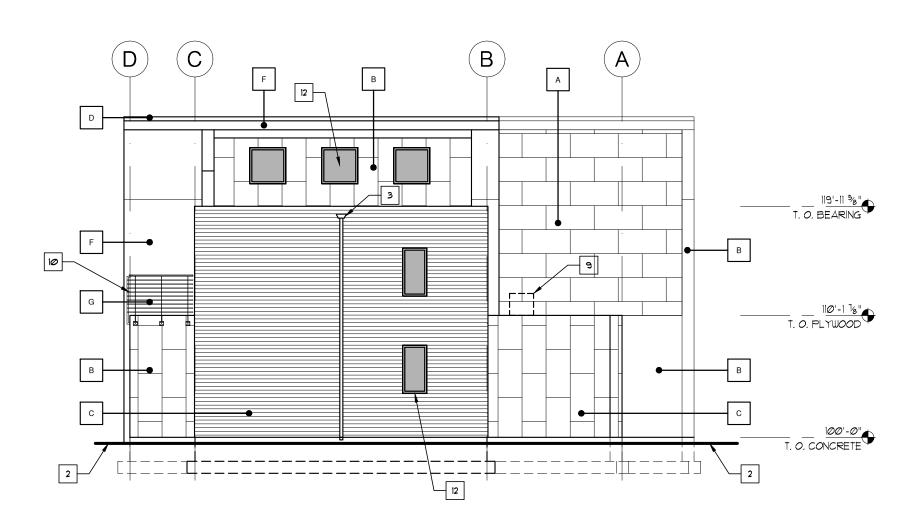

B1 EXTERIOR ELEVATION


SCALE: 1/8" = 1'-0"

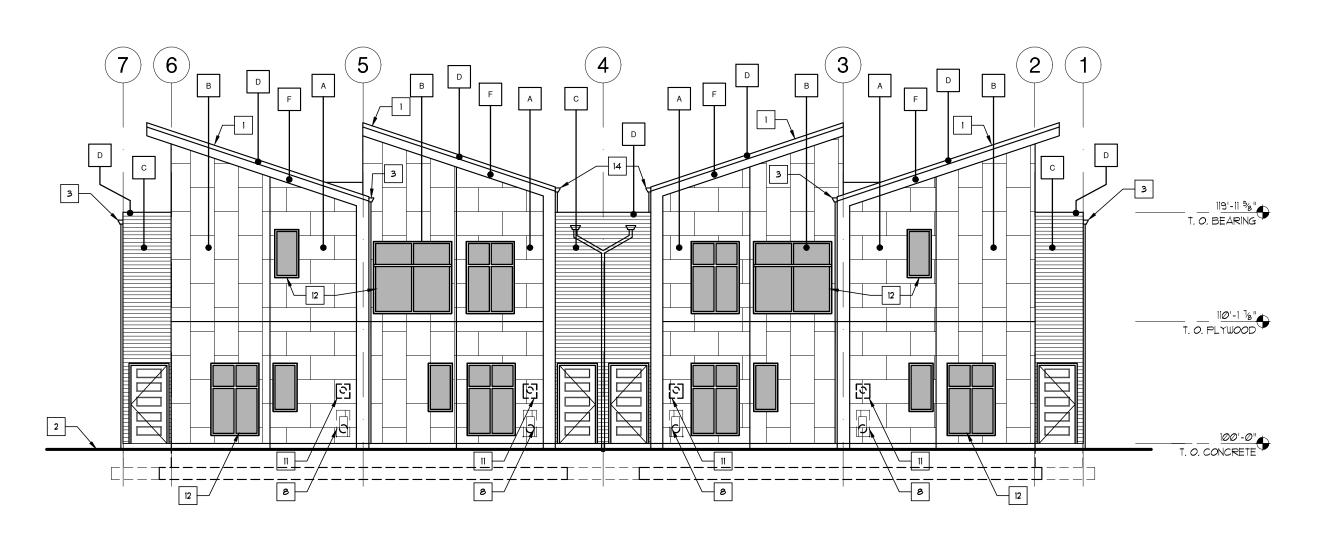

D5 EXTERIOR ELEVATION

SCALE: 1/8" = 1'-0"

### CITY REVIEW NOT FOR CONSTRUCTION

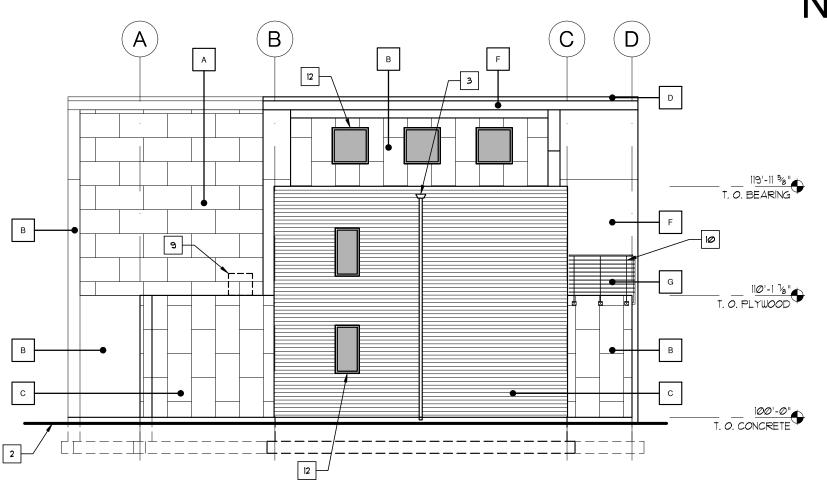


B5 EXTERIOR ELEVATION SCALE: 1/8" = 1'-0"



ELEVATIONS Sheet Title AS NOTED Project Number NOVEMBER 8, 2016 1602SHEETSET.DWG

A3.01

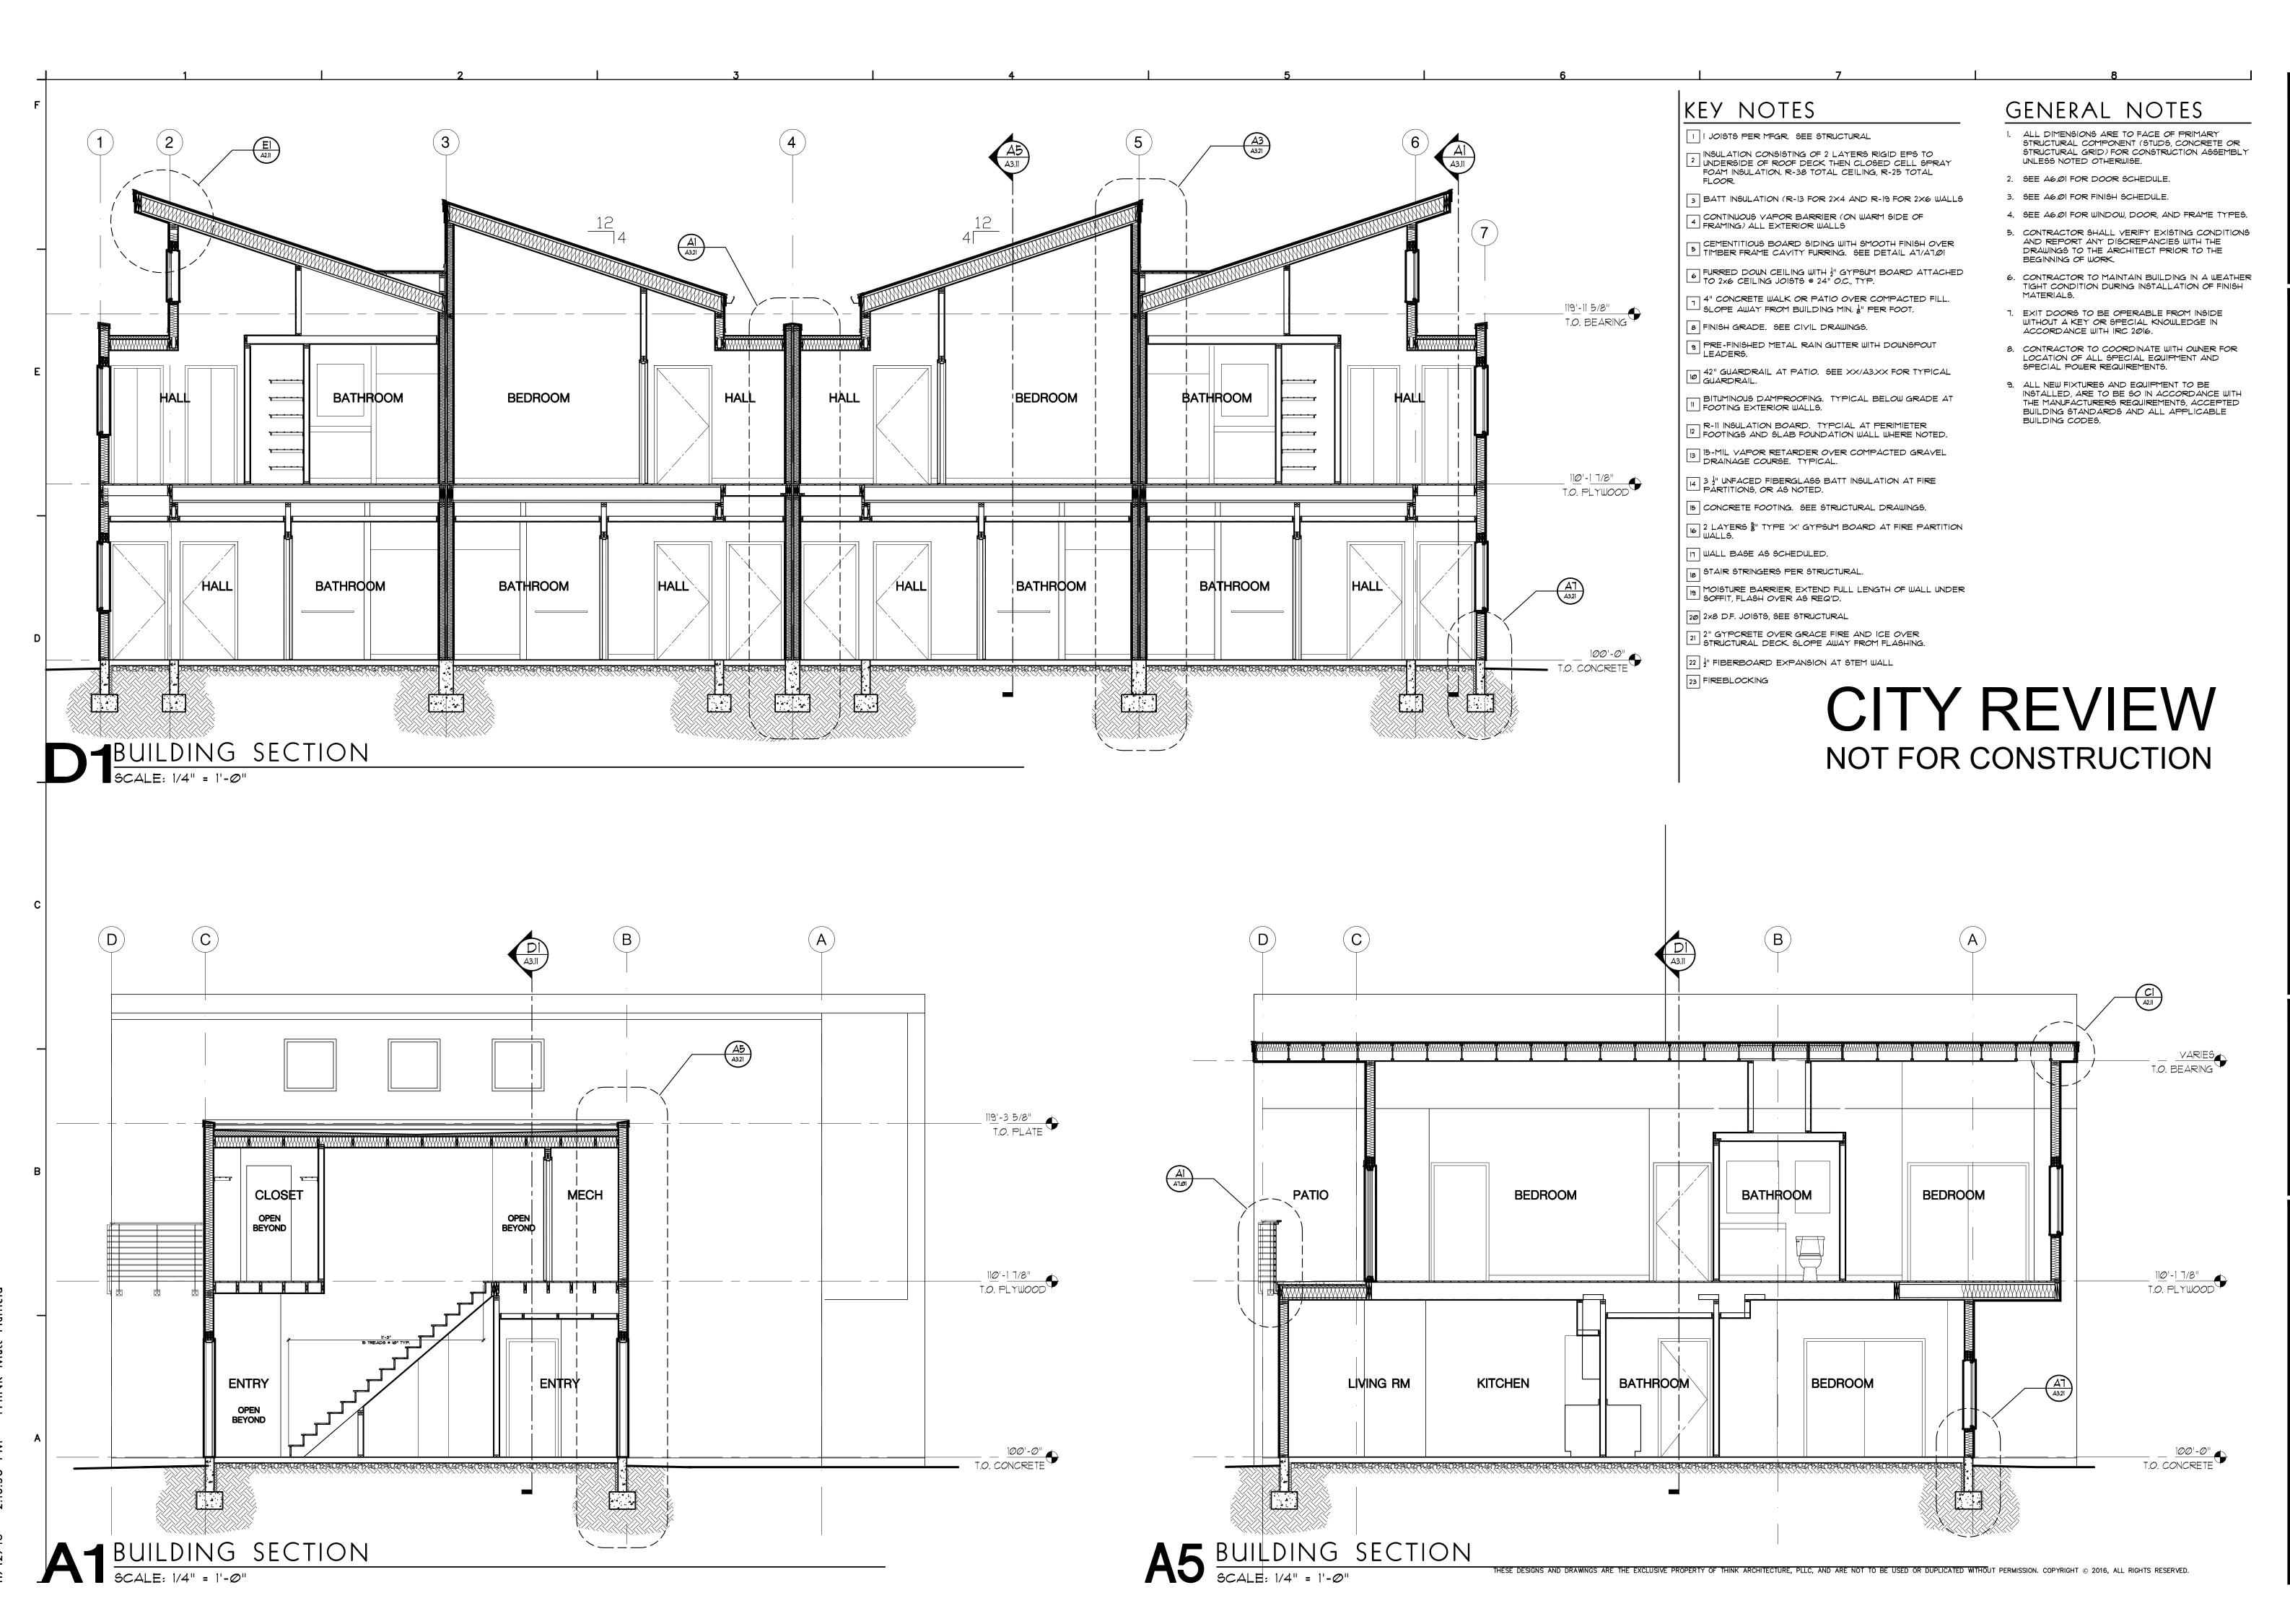

ANCE DEVELOPI

ARCHITECTU

Richland, WA 99352

p: 208.850.7180

Suite B312

1529 Columbia Park Trai

IE 27 ELN HUNTER REN



INSTRUCTION DOCUMENTS AND THE SITE CONDITIONS.
FORMATION REGARDING THE COMPLETE WORK OF
FORICH TRADES IS DISPERSED THROUGHOUT THE
ITIRE DOCUMENT SET AND CANNOT BE ACCURATELY
TERRINED BY REFERENCE TO OTHER THAN COMPLETE
CCUMENT SETS.

BUILDING SECTIONS
Sheet Title


AS NOTED
Scale

NOVEMBER 8, 2016

1602SHEETSET.DWG

evisions

**A3.11** 

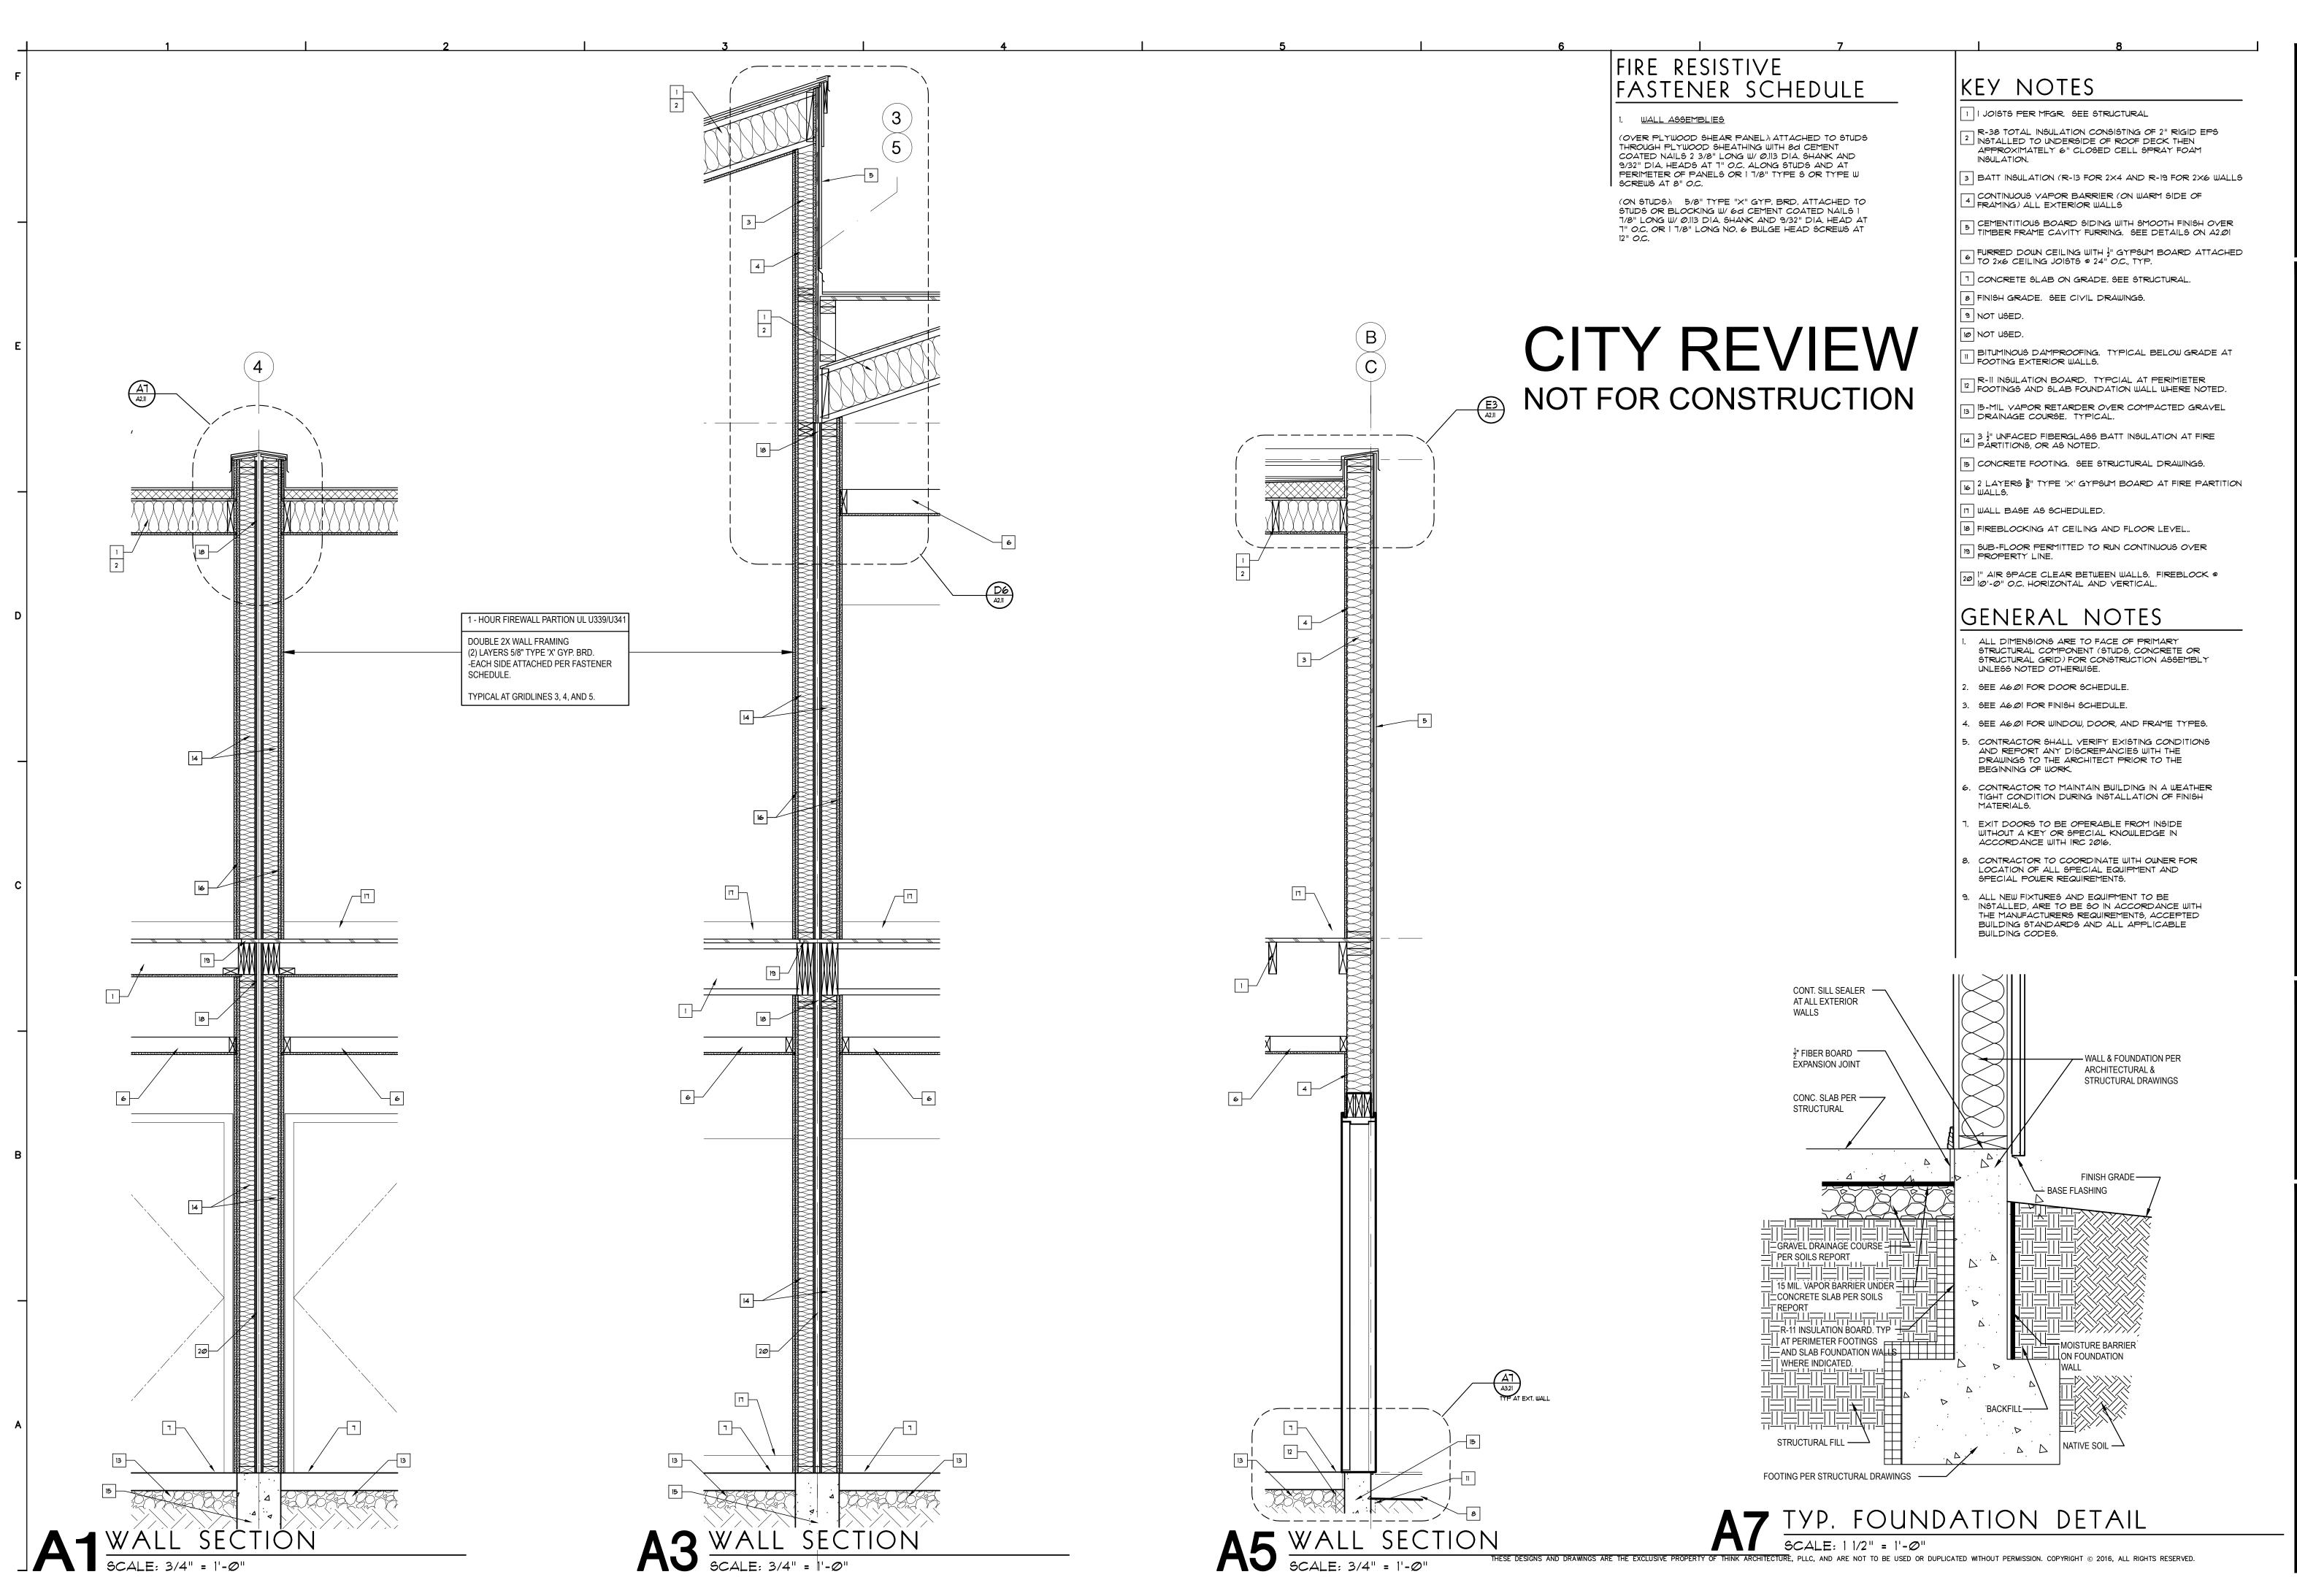



I529 Columbia Park Trai Suite B312 Richland, WA 99352 p: 208.850.7180

VELOPMENT

27 ELM TER RENAISSAN



NFORMATION REGARDING THE COMPLETE WORK OF PECICIC TRADES IS DISPERSED THROUGHOUT THE INTIRE DOCUMENT SET AND CANNOT BE ACCURATELY ETERMINED BY REFERENCE TO OTHER THAN COMPLETE OCCUMENT SETS.

BUILDING SECTIONS
Sheet Title

AS NOTED
Scale


02 oject Number

NOVEMBER 8, 2016
Date

1602SHEETSET.DWG File Name

evisions

A3.21

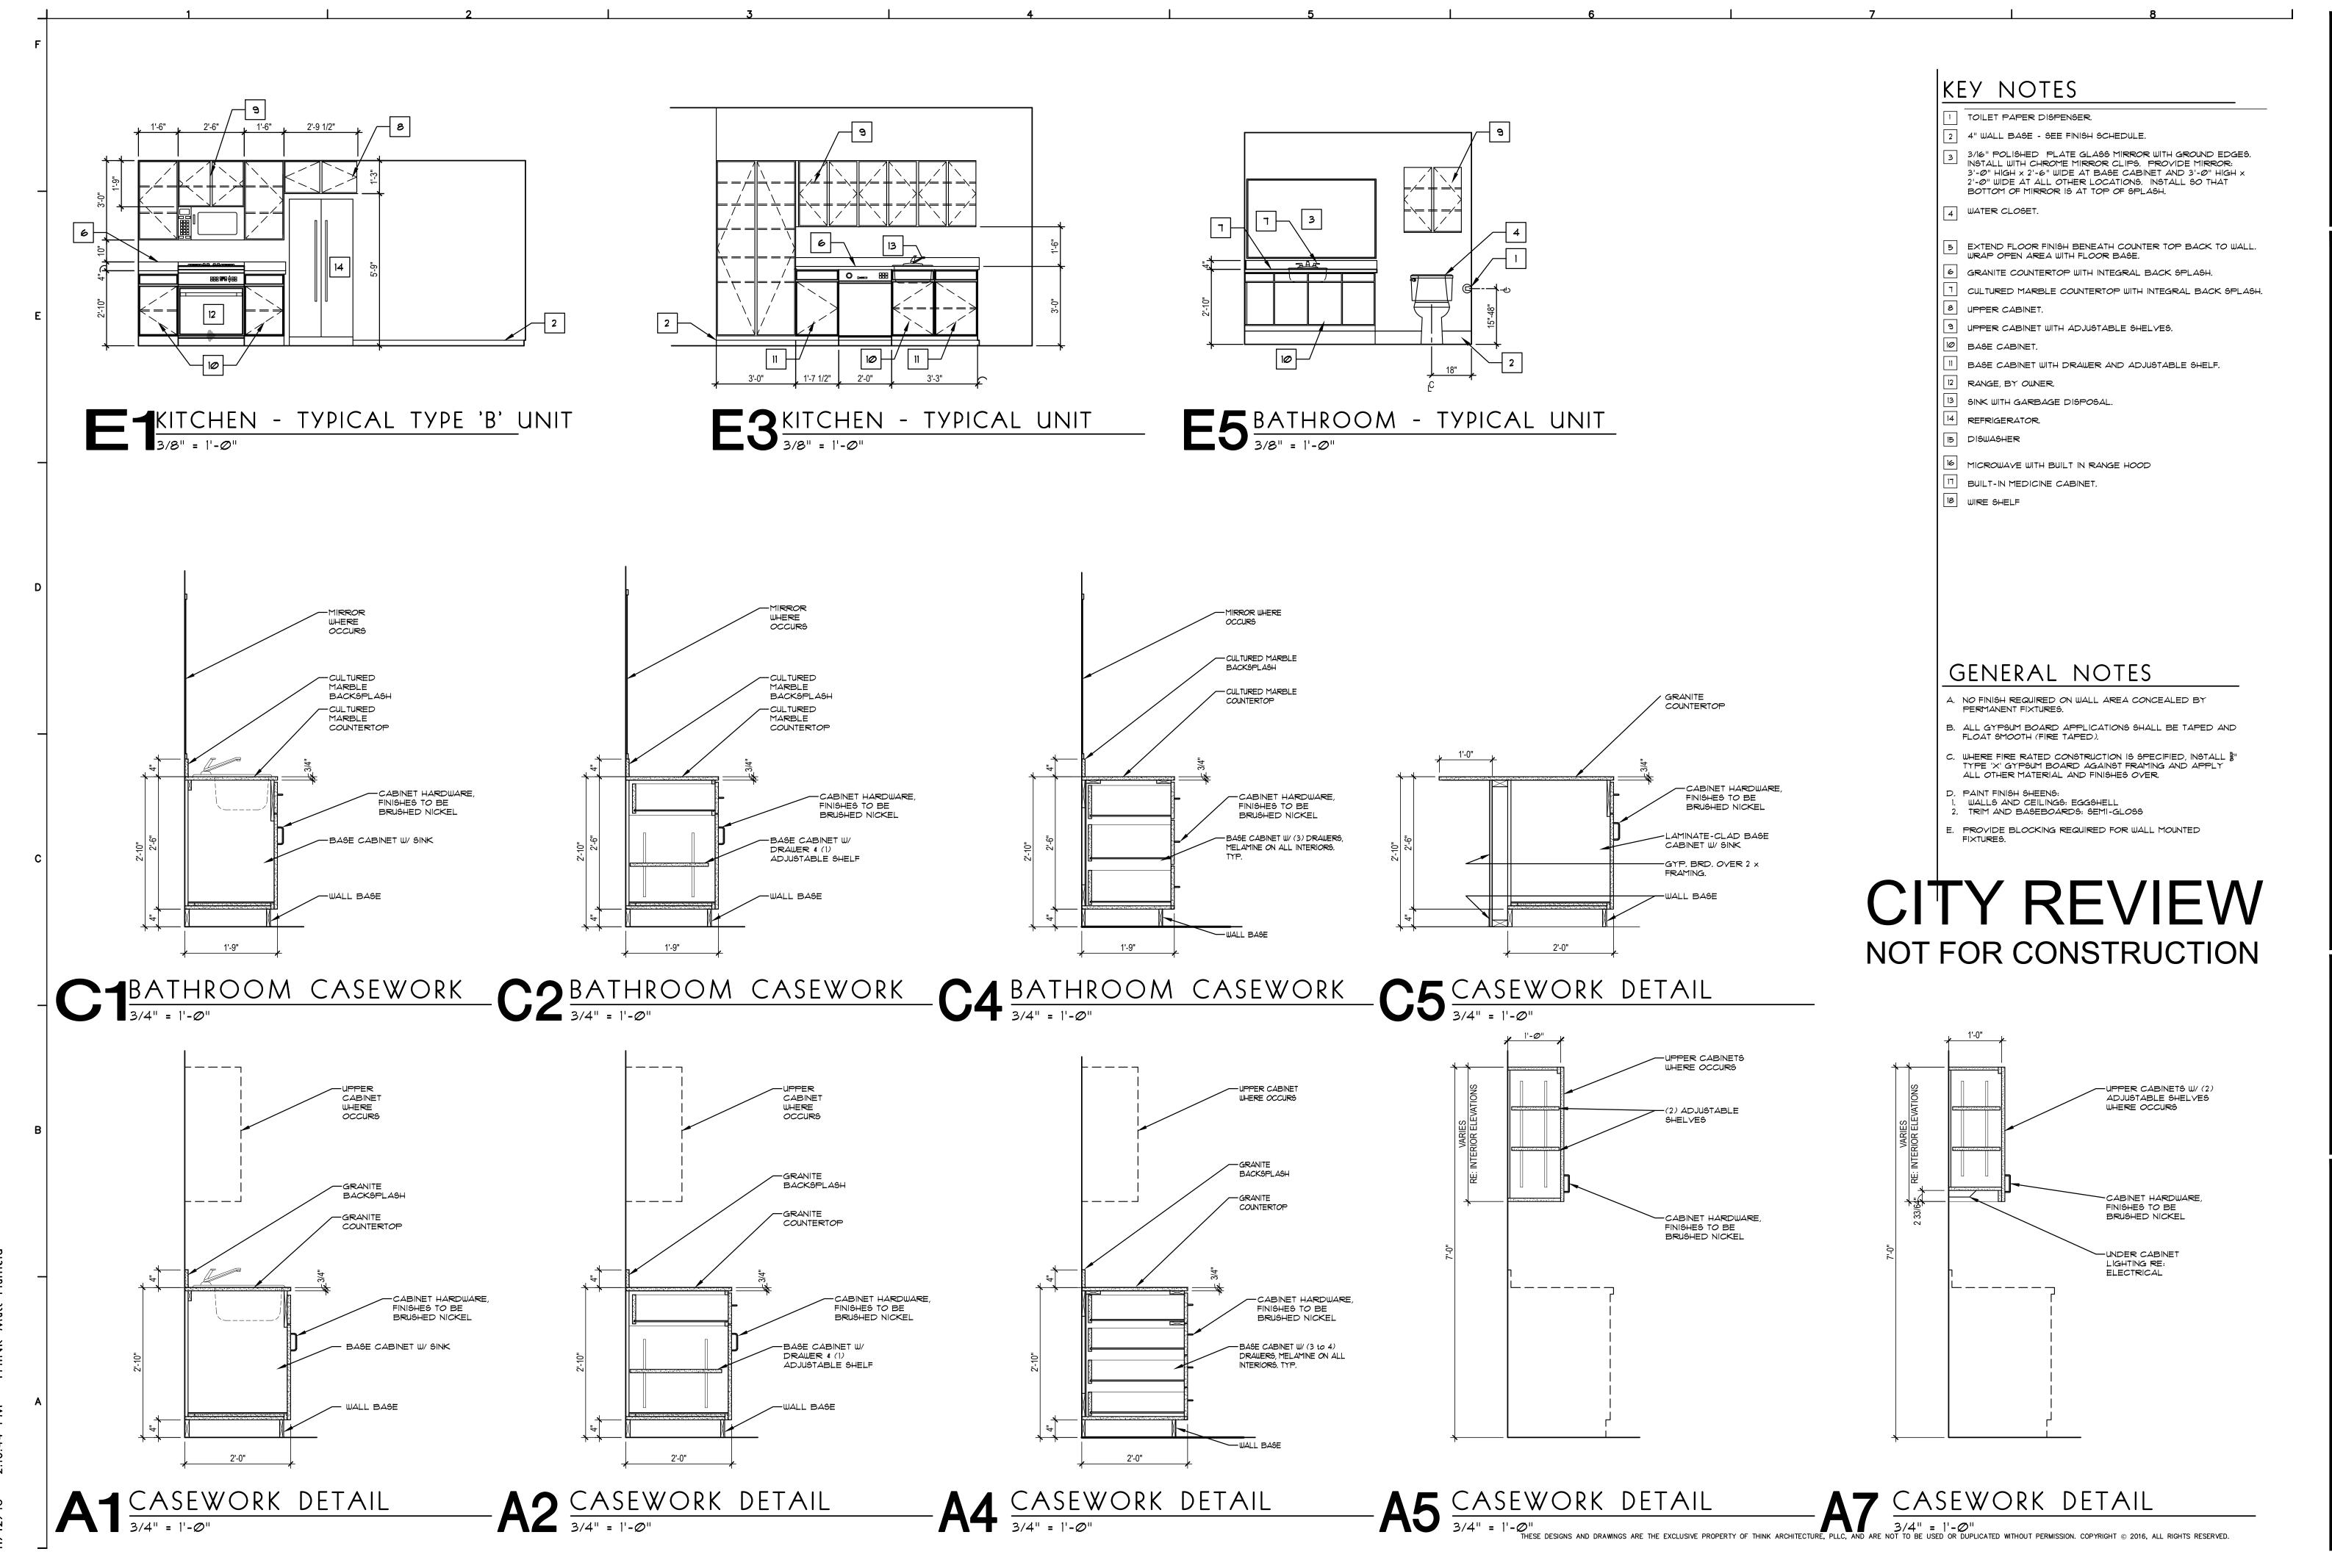

I529 Columbia Park Trail Suite B312 Richland, WA 99352 p: 208.850.7180

Inland, WA 99352 08.850.7180

THE 27 ELM HUNTER RENAISSA

BIDDERS ARE INSTRUCTED TO CAREFULLY REVIEW THE CONSTRUCTION DOCUMENTS AND THE SITE CONDITIONS.

DETERMINED BY REFERENCE TO OTHER THAN COMPLE DOCUMENT SETS.

INT. ELEVATIONS

Sheet Title

AS NOTED
Scale
1602
Project Number

NOVEMBER 8, 2016
Date

1602SHEETSET.DWG File Name

Revisions

A5.01

UNIT FINISH SCHEDULE							
ROOM	FLOOR	BASE	WALLS	CEILING	REMARKS		
ENTRY/STAIRWELL	Α	G	L	L			
KITCHEN	Α	G	L	L	CABINETS - I &J COUNTERTOPS - E (SEE INT. ELEVATIONS)		
BATH	С	G	L	L	CABINETS - K; COUNTERTOPS - F (SEE INT. ELEVATIONS)		
LIVING/DINING	A	G	L	L			
MASTER BEDROOM	В	G	L	L			
BEDROOM	В	G	L	L			
HALLWAY	А	G	L	L			
HALLWAY 2ND FLOOR	В	G	L	L			
LAUNDRY	D	G	L	L			
STORAGE	А	G	L	L			
PATIO	G				SEE ELEVATIONS FOR EXTERIOR FINISHES		
MECHANICAL	Α	G	М				

### MATERIAL FINISH SCHEDULE:

- A VINYL PLANK, ARMSTRONG #A6422, CONCRETE STRUCTURES-SOHO GRAY
- B BROADLOOM CARPET- 25-30 OZ, COLOR SELECTED BY OWNER
- C TILE DALTILE P620, DUNE
- D VCT ARMSTRONG, COLOR SELECTED BY OWNER
- E COUNTERTOPS GRANITE, COLOR AND FINISH SELECTED BY OWNER
- F COUNTERTOPS CULTURED MARBLE, SOLID WHITE, FINISH SELECTED BY OWNER
- G MDF BASE BOARD, PAINT WHITE TO MATCH VINYL WINDOWS (PROFILE AND COLOR SELECTED BY OWNER)
- H SEALED LIGHTWEIGHT CONCRETE AT PATIOS
- I CABINETS LEEDS EUROSTYLE SLAB DOOR, SLATE GRAY (HOME DEPOT)
- J CABINETS LEEDS EUROSTYLE COPENHAGEN, GLASS DOOR ACCENT, SLATE GRAY (HOME DEPOT)
- K CABINETS GLASGOW EUROSTYLE SLAB DOOR; LEGS, CHOCOLATE (HOME DEPOT)
- L GYP BOARD PAINTED, COLORS SELECTED BY OWNER.
- M GYP BOARD PAINTED, FIRE TAPED

UNIT DOOR SCHEDULE									
NUMBER /TYPE	SIZE	THICK- NESS	CONSTR- UCTION	FINISH	GLASS	FRAME	RATING	HARD- WARE	REMARKS
1	3'-0" X 6'-8"	1-3/4"	SOLD CORE WD	PAINT	-	WD	-	1	PROVIDE CHAIN LATCH, WEATHERSTRIPPING EXTERIOR GRADE WOOD DOOR, & KNOCKER W/ VIEWER (AT UNIT ENTRY DOORS)
1A	3'-0" X 6'-8"	1-3/8"	WD	PAINT	-	WD	-	2	UNDERCUT DOORS 1"
1B	2'-8" X 6'-8"	1-3/8"	WD	PAINT	-	WD	-	2	UNDERCUT DOORS 1"
1C	3'-0" X 6'-8"	1-3/8"	WD	PAINT	-	WD	-	5	POCKET DOOR, UNDERCUT DOORS 1"
2	6'-0" X 6'-8"	1-3/8"	WD	PAINT	-	WD	-	4	PROVIDE MIRRORS ON BOTH PANELS
3	7'-0" X 6'-8"	1-3/8"	WD	PAINT	-	WD	-	3	DOUBLE BI-FOLD
3A	4'-0" X 6'-8"	1-3/8"	WD	PAINT	-	WD	-	3	DOUBLE BI-FOLD
3B	2'-8" X 6'-8"	1-3/8"	WD	PAINT	-	WD	-	3	SINGLE BI-FOLD
3C	2'-0" X 6'-8"	1-3/8"	WD	PAINT	-	WD	-	3	SINGLE BI-FOLD
4	6'-0" X 6'-8"	-	VINYL	WHITE	-	WD	-	-	HARDWARE BY MANUFACTURER
NOTES:		•		•				•	

- ALL GLAZING WITHIN 24" OF A DOOR TO BE TEMPERED GLASS.
- 2. ALL HARDWARE TO BE BRUSHED ALUMINUM FINISH.
- 3. ALL INTERIOR DOORS TO BE JELD-WEN SMOOTH 5-PANEL MOLDED DOORS OR APPROVED EQUAL.

### Hardware Schedule:

- Group 1 Unit Entry Door
- a. 1-1/2 pair 4"x4" hinges by manufacturer 26D.
- b. 1 Schlage passage Broadway lever with #82 deadbolt 26D KW keyway.
- c. 1 Cal-Royal combination door viewer/door knocker #DK94 x 26D or approved
- d. 1 Cal-Royal Jumbo Flex Stop JFS-1 US 15A or approved equal.
- e. 1 set weather stripping
- f. 1 Trimco BBW 4048 Chain crash stop 26D

### Group 2 - Bath and Bedroom Doors

- a. 1-1/2 pair hinges 3-1/2"x3-1/2"x5/8" radius US26D by manufacturer.
- b. 1 Schlage privacy Broadway lever 26D finish.
- c. 1 Cal-Royal Jumbo Flex Stop JFS-1 US 15A or approved equal.

### Group 3 – Bi-fold Doors

- a. All hardware by door manufacturer.
- b. 2 Cal-Royal Finger Pulls DIFP218 26D finish or approved equal.

### Group 4 – Bi-pass Doors

- a. All hardware by door manufacturer.
- b. 2 Cal-Royal Finger Pulls DIFP218 26D finish or approved equal

- a. Johnson Hardware series 2511 Pocket Door Frame with jump proof box track, optional
- hidden door guides, and adjustable door hangers/slides. b. Omnia Modern Collection Rectangular flush pull with privacy latch. US26D

a. Unit Locks: Storage and Entry locks keyed alike per unit. All unit keys keyed to master. Provide four keys per unit.


### b. Provide enough interchangeable cores for five additional units for turnover purposes.


- LEGEND

T	= TE	EMPE	RED
WD =	: WC	OD	

$\Diamond$	WINDOW SCHEDULE						
NUMBER / TYPE	SIZE	FRAME	FINISH	GLASS	REMARKS		
Α	6'-6" X 6'-0"	VINYL	WHITE	INSULATED	DUAL-GLAZED LOW-E SHGC 0.63		
В	6'-" X 6'-0"	VINYL	WHITE	INSULATED	DUAL-GLAZED LOW-E SHGC 0.63		
С	4'-0" X 6'-0"	VINYL	WHITE	INSULATED	DUAL-GLAZED LOW-E SHGC 0.63		
D	3'-0" X 3'-0"	VINYL	WHITE	INSULATED	DUAL-GLAZED LOW-E SHGC 0.63		
Е	2'-0" X 4'-0"	VINYL	WHITE	INSULATED	DUAL-GLAZED LOW-E SHGC 0.63		
NOTES:		•					

1. ALL GLAZING WITHIN 24" OF A DOOR TO BE TEMPERED GLASS. PROVIDE SCREENS ON OPERABLE PANELS OF ALL WINDOWS.

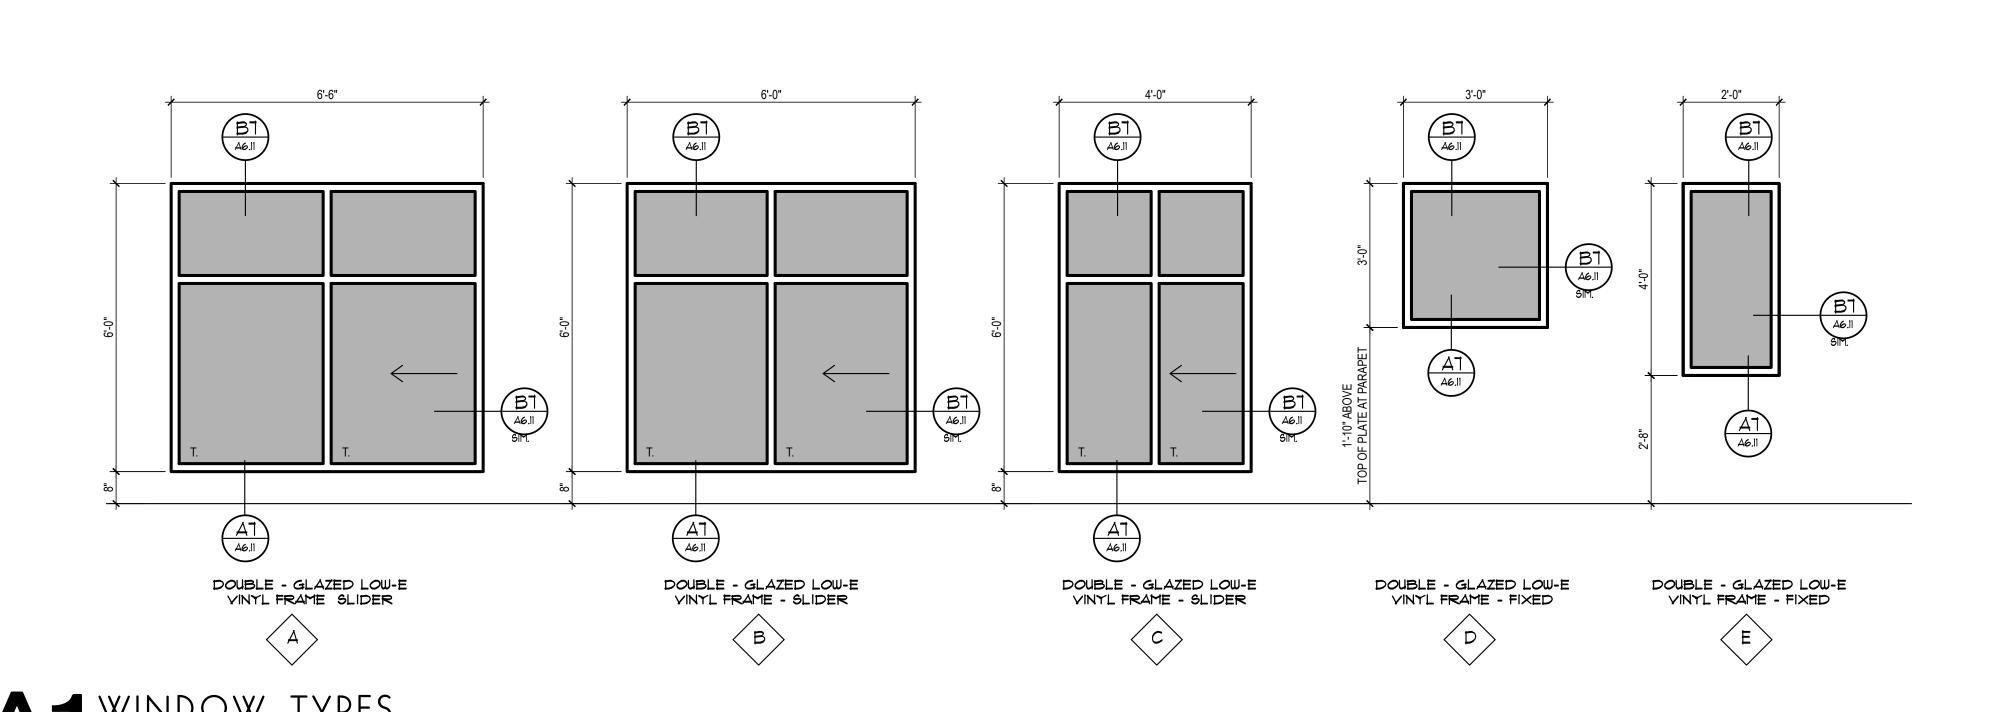

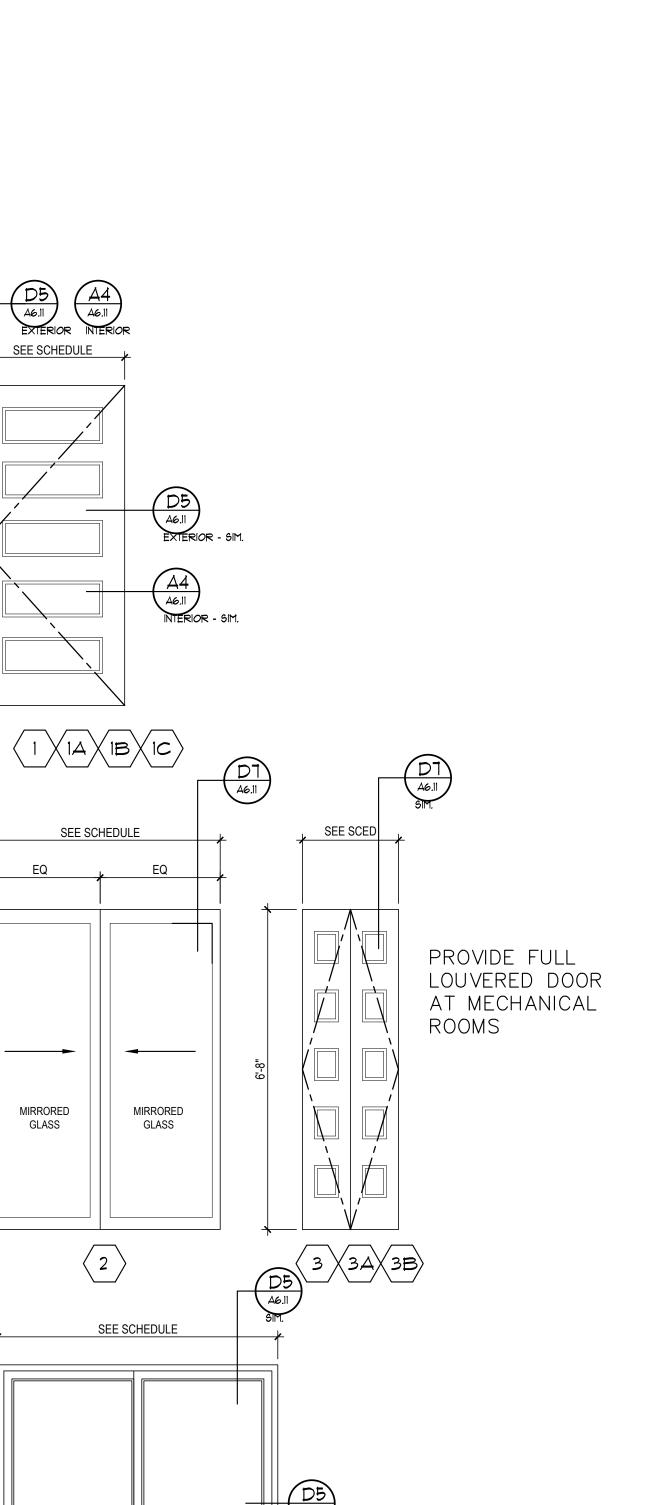


CONFIRM SLIDE DIRECTION WITH

PLAN

THESE DESIGNS AND DRAWINGS ARE THE EXCLUSIVE PROPERTY OF THINK ARCHITECTURE, PLLC, AND ARE NOT TO BE USED OR DUPLICATED WITHOUT PERMISSION. COPYRIGHT © 2016, ALL RIGHTS RESERVED.

CITY REVIEW

NOT FOR CONSTRUCTION

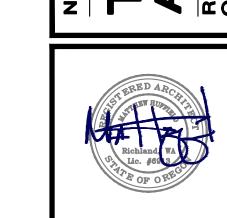


1529 Columbia Park Trai

EVEL

Richland, WA 99352 p: 208.850.7180

Suite B312

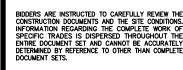


SCHEDULES AS NOTED NOVEMBER 8, 2016

1602SHEETSET.DWG

A6.01

### CITY REVIEW NOT FOR CONSTRUCTION



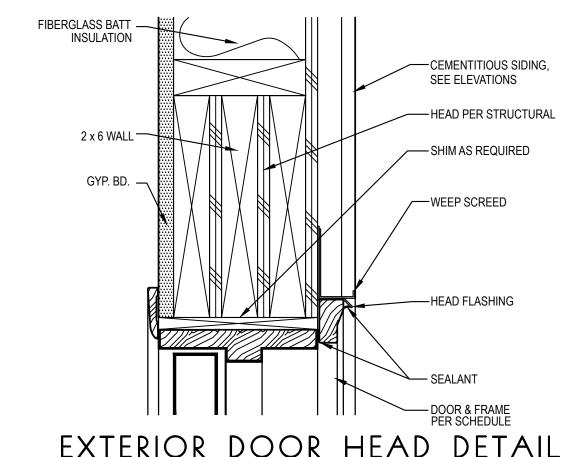



EACH SIDE TRACK AND HARDWARE BY MANUFACTURER SCHEDULE

EXTERIOR DOOR HEAD DETAIL

AT SIDING/JAMB SIMILAR

3" = 1'-0"

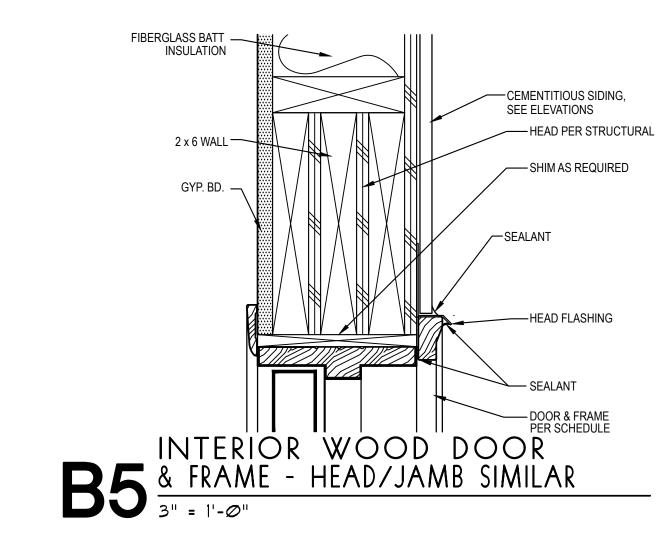


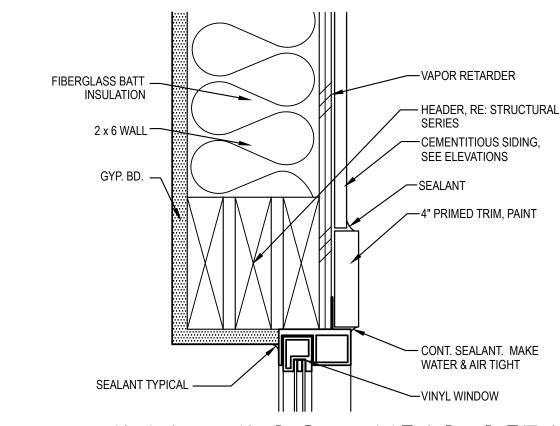



B7 VINYL WINDOW HEAD DETAIL

AT SIDING EXTERIOR/JAMB SIMILAR

3" = 1'-0"

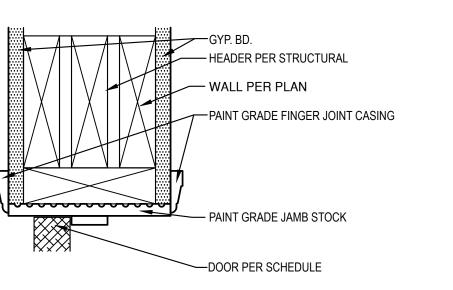

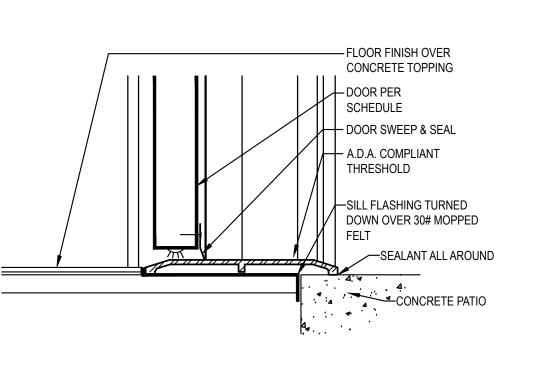

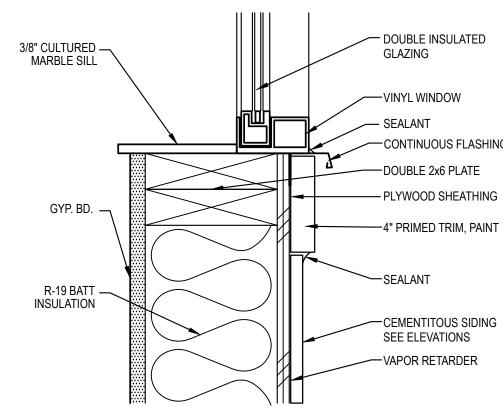

AT SIDING EXTERIOR

3" = 1'-0"

A4 UNIT INTERIOR WOOD DOOR & FRAME - HEAD/JAMB SIMILAR

3" = 1'-0"

THESE DESIGNS AND DRAWINGS ARE THE EXCLUSIVE PROPERTY OF THINK ARCHITECTURE, PLLC, AND ARE NOT TO BE USED OR DUPLICATED WITHOUT PERMISSION. COPYRIGHT @ 2016, ALL RIGHTS RESERVED.

A6.11

DETAILS Sheet Title

AS NOTED

Project Number

NOVEMBER 8, 2016

1602SHEETSET.DWG

TYPICAL FIBER CEMENT

GYP-CRETE TOPPING

OVER PLYWOOD

SHEATHING ——

- DOOR PER

SCHEDULE

ADA COMPLIANT THRESHOLD

SET ON FLASHING & OVER

ICE SHIELD AND DOWN WALL

- CONC. TOPPING & PLYWOOD

GRACE FIRE AND ICE SHIELD


OVER SHEATHING AND UP


WALL UNDER FLASHING

DECK PER STRUCTURAL


- CONT. SEALANT BEAD EACH SIDE

LAPPING GRACE FIRE AND

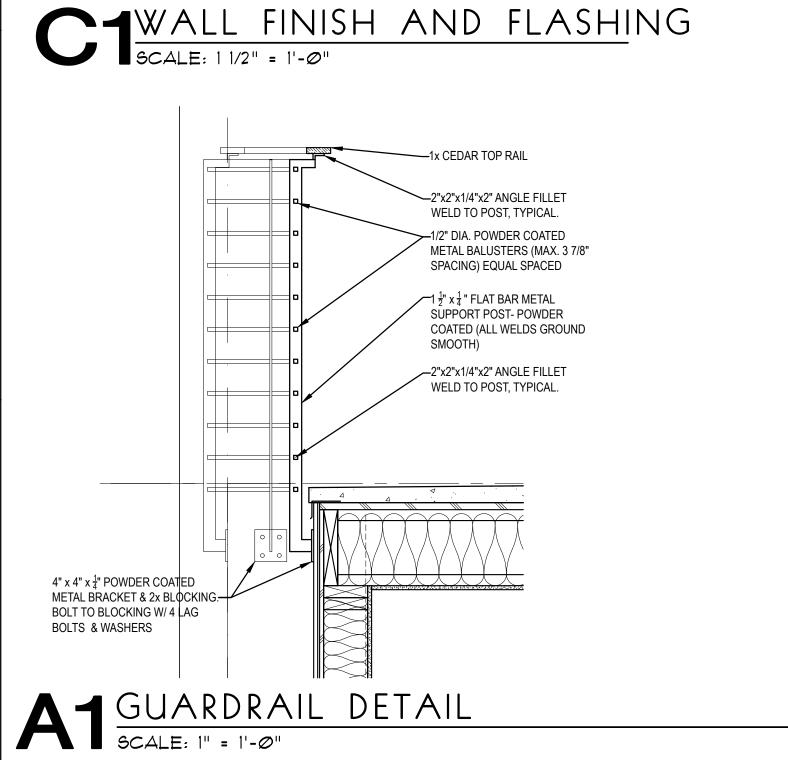

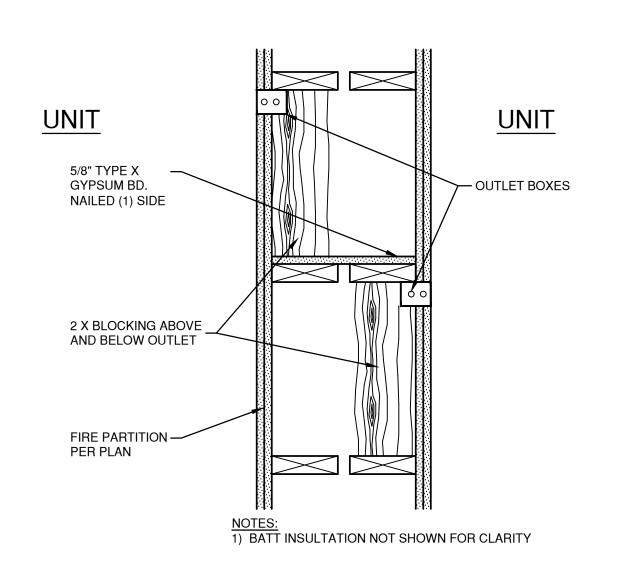


# LISTED ELECTRICAL OUTLET BOXES FIRE MEMBRANE PENETRATION SCALE: 1 1/2" = 1'-0"

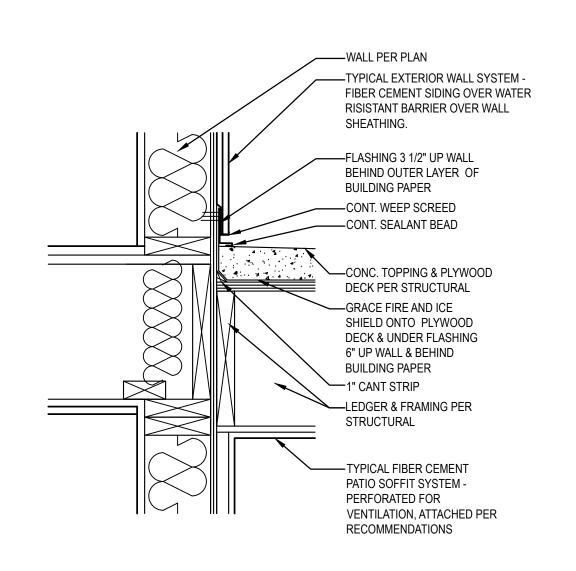


C5 PATIO DETAIL AT WALL

SCALE: 1 1/2" = 1'-0"

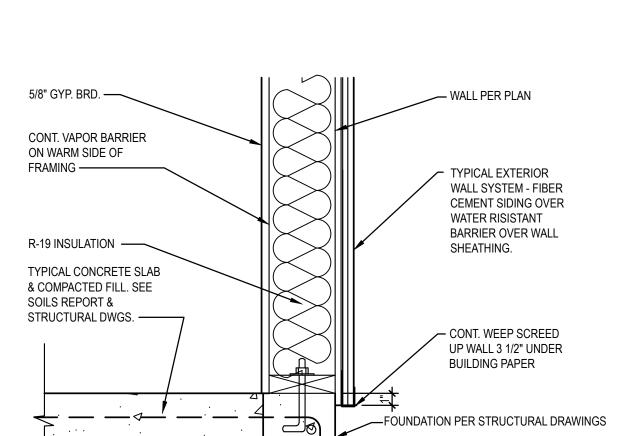



### CITY REVIEW NOT FOR CONSTRUCTION

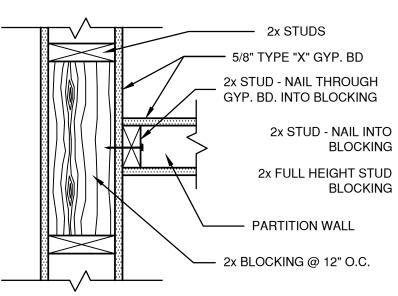



PRAMING DETAIL

SCALE: 1 1/2" = 1'-0"

CONC. TOPPING & PLYWOOD —— DECK PER STRUCTURAL 1/2" BULLNOSE ----2 1/2" MIN. THICKNESS TYP. AT ALL PATIO SLAB EDGES PRE-FINISHED METAL FLASHING DOWN 2" OVER HARDIE BOARD OVER PLYWOOD DECK & OVER FLASHING CEILING ASSEMBLY SEE -**BUILDING SECTIONS** TYPICAL EXTERIOR WALL SYSTEM - FIBER CEMENT SIDING VERTICAL OR HORIZONTAL SIDING OVER WATER RESISTANT BARRIER OVER WALL SHEATHING. SEE EXTERIOR

C7 PATIO DETAIL AT GUARDRAIL

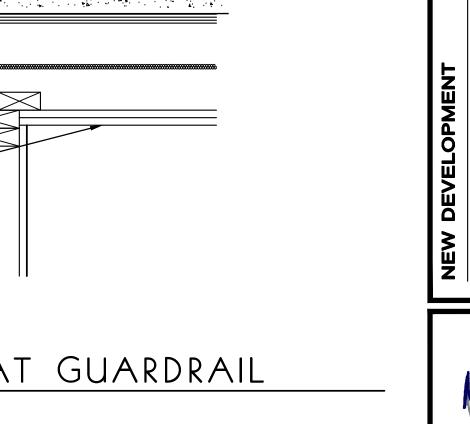

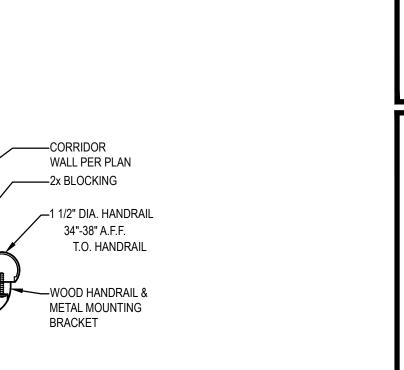

Project Number NOVEMBER 8, 2016

MISC. DETAILS

AS NOTED

1529 Columbia Park Tra

Richland, WA 99352

p: 208.850.7180

Suite B312

1602SHEETSET.DWG

Revisions

A7.01